


REPLACE PUBLIC WORKS SHOP CG SECTOR NORTH CAROLINA ATLANTIC BEACH, NC

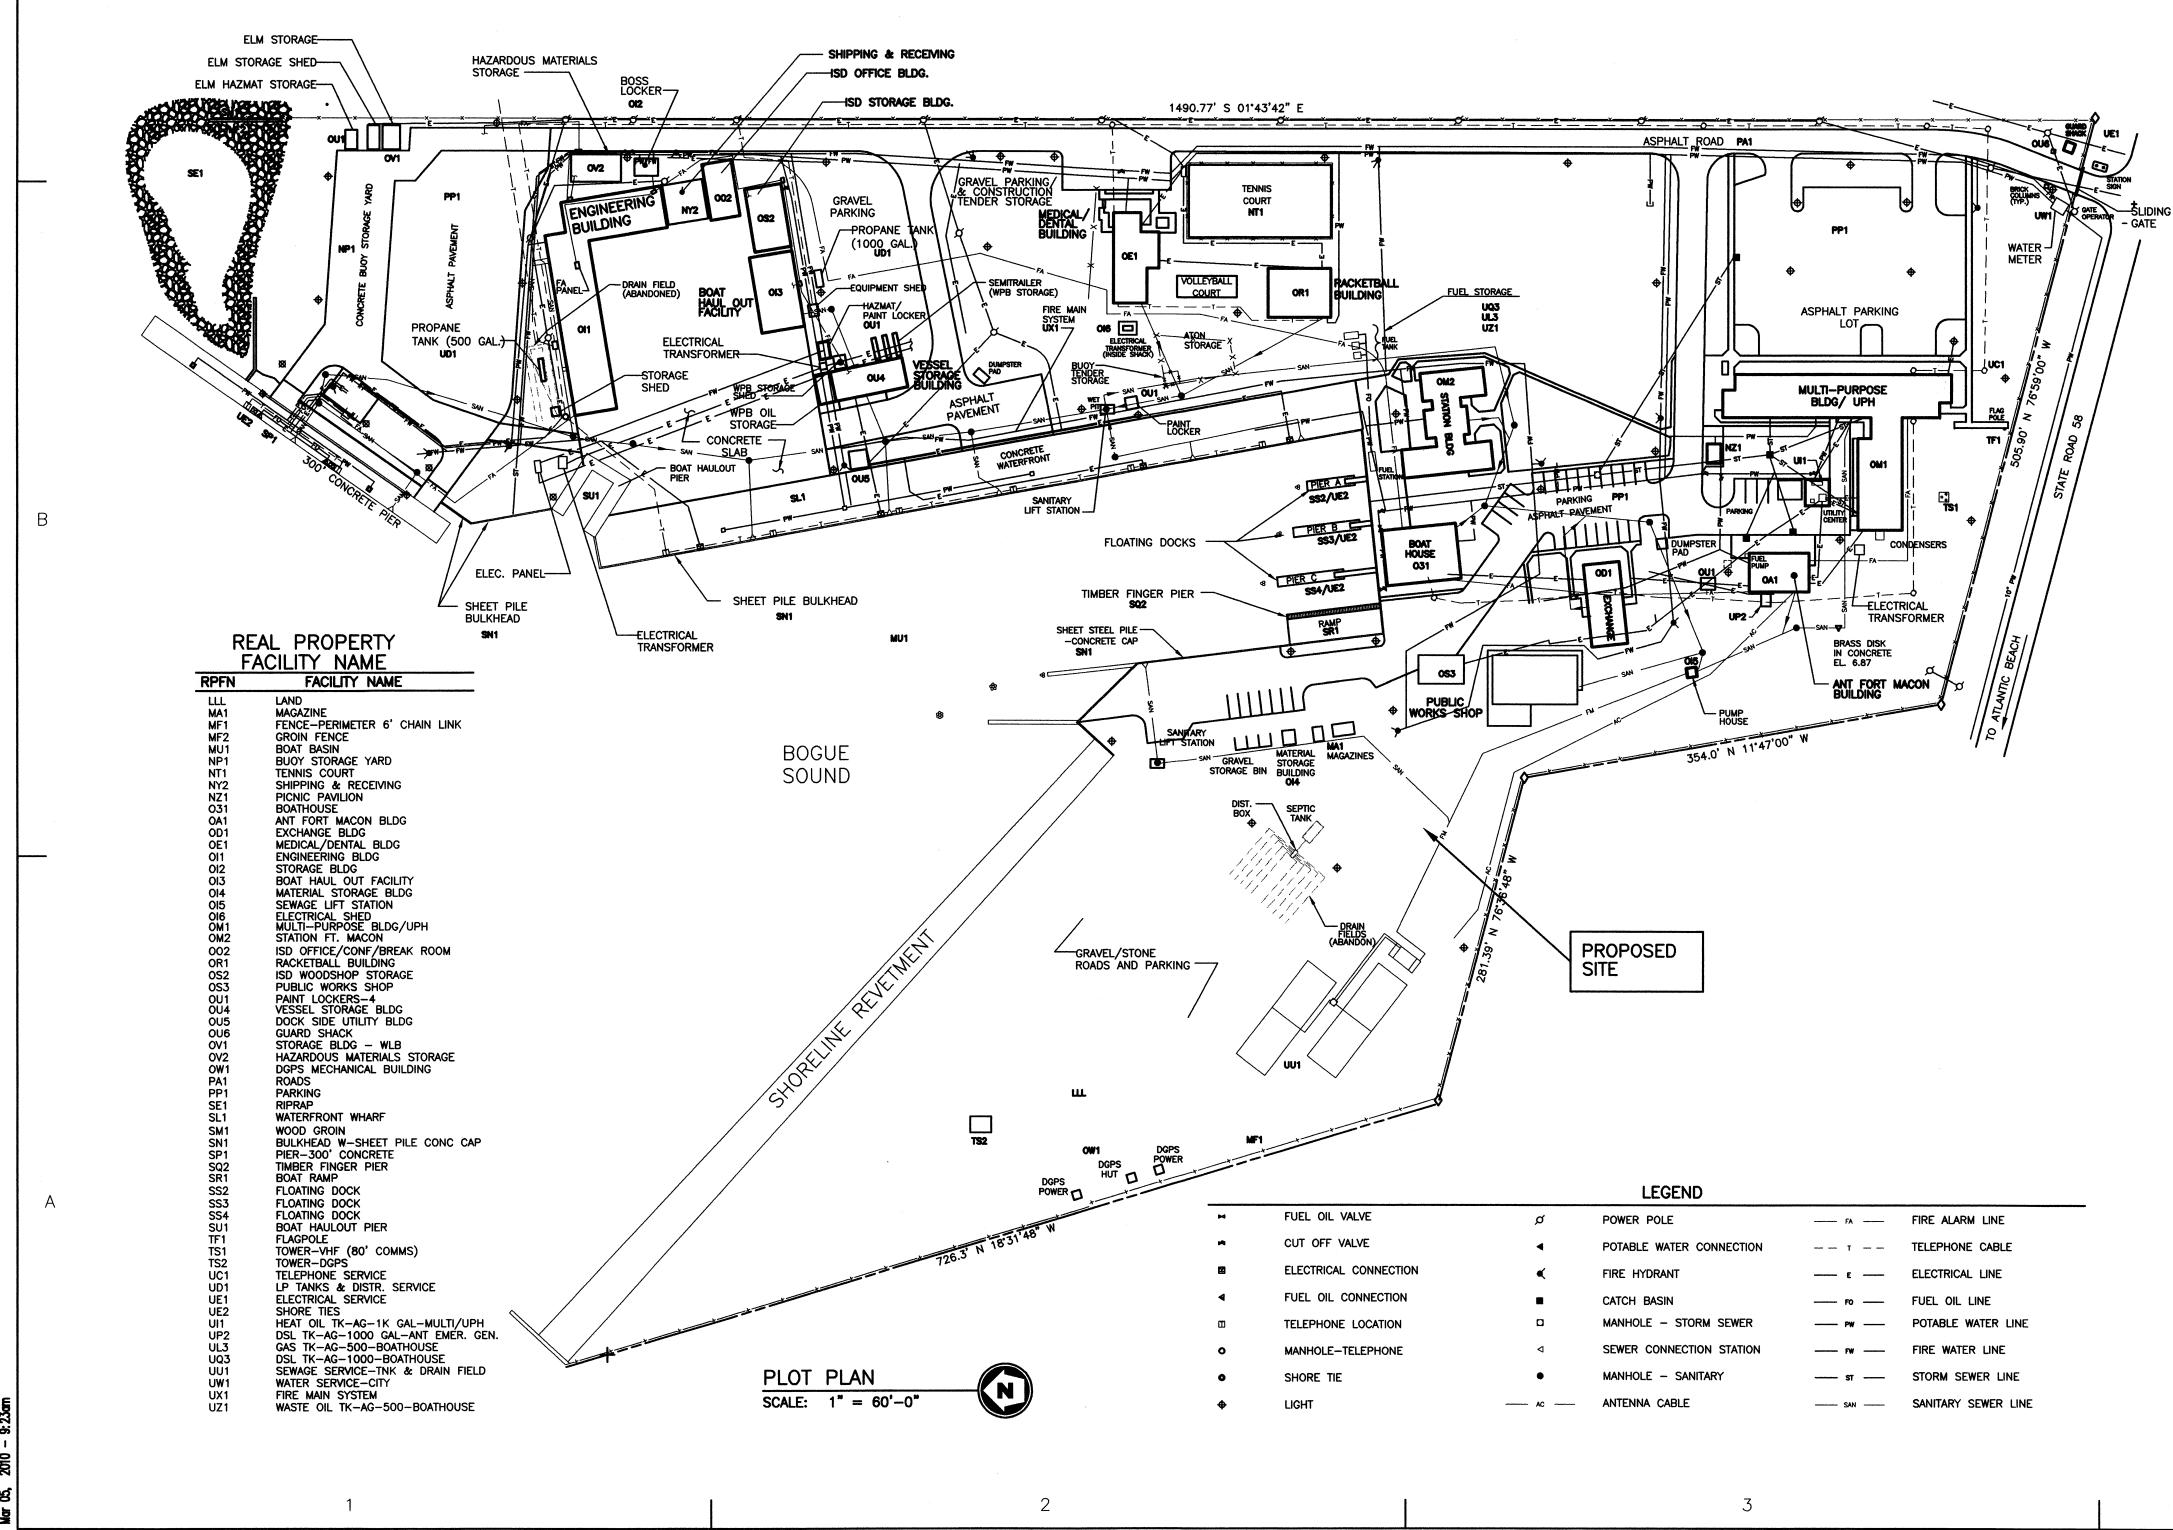

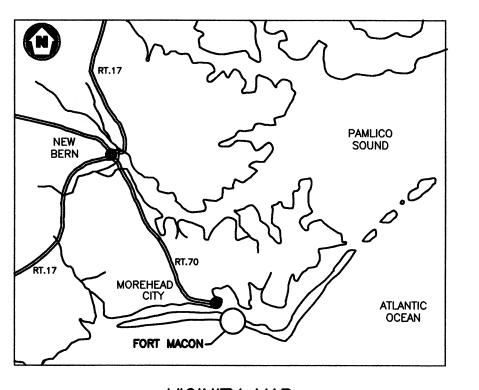

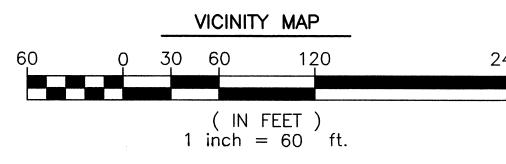

USCG CEU CLEVELAND, OHIO (216) 902-6200

CONSULTANT

THE JOHNSON—McADAMS FIRM GREENWOOD, MISSISSIPPI 662-455-4943



U. S. COAST GUARD CIVIL ENGINEERING UNIT CLEVELAND



USCG. CEU CLEVELAND 1240 EAST 9TH STREET CLEVELAND, OH 44199-2060

-		
MARK	DATE	DESCRIPTION

A/E PROJECT NO	
CAD FILE NAME:	C7648T01
DESIGNED BY:	JGM
DRAWN BY:	ADD
EDITED BY:	ADD
CHECKED BY:	JGM

SCALE: AS SHOWN PLOT SCALE: 1:1

SHEET TITLE

REPLACE PUBLIC WORKS SHOP
CG SECTOR NORTH CAROLINA
ATLANTIC BEACH NORTH CAROLINA
PUBLIC WORKS SHOP
ARCHITECTURAL
TITLE SHEET

PROJECT AND DEPARTMENT OF THE PROJECT AND DESCRIPTION OF THE P

PROJECT NUMBER DRAWING NUMBER

05-C05124 7648-D

DISCIPLINE/SHT NO

T-01 SHEET 1 OF 28

ant Projects/USCG/Atlantic Beach/C7648TO1.d


	DRAWING INDEX					
REF. NO.	SHEET NO.	TITLE				
1	T-01	TITLE SHEET				
2	T-02	DRAWING INDEX				
3	C-01	EXISTING SITE				
4	C-02	CIVIL				
5	C-03	LIFT STATION DETAIL				
. 6	C-04	CIVIL DETAILS				
7	S-01	STRUCTURAL REQUIREMENTS				
8	S-02	STRUCTURAL DETAILS				
9	S-03	FOOTING DETAILS				
10	S-04	MISC. STRUCTURAL DETAILS				
11	A-01	FLOOR PLAN				
12	A-02	ELEVATIONS				
13	A-03	SCHEDULES				
1.4	A-04	ENLARGED PLAN/ELEVATIONS				
15	A-05	ENLARGED STAIRS				
16	A-06	BLDG. SECTIONS				
17	A-07	DETAILS				
18	M-01	FLOOR PLAN MECHANICAL				
19	M-02	FLOOR PLAN MECHANICAL				
20	M-03	MECHANICAL SCHEDULES				
21	P-01	FLOOR PLAN PLUMBING				
22	E-01	FLOOR PLAN POWER				
23	E-02	FLOOR PLAN POWER				
24	E-03	FLOOR PLAN LIGHTING				
25	E-04	FLOOR PLAN LIGHTING				
26	E-05	SINGLE LINE & SCHEDULES				
27	FP-01	FLOOR PLAN FIRE ALARM				
28	FP-02	FLOOR PLAN FIRE ALARM				

ABB	REVIATIONS			LEGEND AND SYMBO	DLS
@ APPROX. BLDG. Q CONC. CONT. DIA . EA . EL EQUIP. EXIST.	AT APPROXIMATE BUILDING CENTERLINE CONCRETE CONTINUOUS DIAMETER EACH ELEVATION EQUIPMENT EXISTING	MAX MFR. MIN. N.A. O.C. PVMT. PSI PTD REQ'D. SCH TBM	MAXIMUM MANUFACTURER MINIMUM NOT APPLICABLE ON CENTER PAVEMENT POUNDS PER SQUARE INCH PAINTED REQUIRED SCHEDULE TEMPORARY BENCH MARK	INDICATES DETAIL NUMBER INDICATES SHEET WHERE DETAIL IS DRAWN INDICATES ORIGIN SHEET OF DETAIL MARK INDICATES DETAIL NUMBER DETAIL TITLE AT AT DRAWING SCALE INDICATES SHEET WHERE DETAIL IS DRAWN INDICATES ORIGIN SHEET OF DETAIL DRAWING TITLE	INDICATES DRAWING NUMBER INDICATES DIRECTION SECTION IS DRAWN INDICATES SHEET WHERE SECTION IS DRAWN INDICATES ORIGIN SHEET OF SECTION SECTION MARK OFFICE ROOM NAME AND NUMBER 124 DOOR LEAF NUMBER 123 WINDOW NUMBER
FT.	FOOT	TYP. W/	TYPICAL WITH	INDICATES REFERENCE TO KEYED NOTE KEYED NOTE INDICATES ELEVATION NUMBER INDICATES SHEET WHERE ELEVATION IS DRAWN INDICATES ORIGIN SHEET OF ELEVATION ELEVATION MARK	14'-0" A.F.F. ELEVATION ABOVE FIN. FLOOR 283.00 ELEVATION (FEET) 100 0 100 200 MILE SCALE 1"=100 MILES GRAPHIC SCALES

USCG CEU CLEVELAND, OHIO (216) 902-6200

CONSULTANTS

THE JOHNSON-McADAMS FIRM GREENWOOD, MISSISSIPPI 662-455-4943

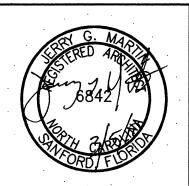

U. S. COAST GUARD CIVIL ENGINEERING UNIT CLEVELAND



USCG. CEU CLEVELAND 1240 EAST 9TH STREET CLEVELAND, OH 44199-2060

ISSUE			
MARK	DATE	DESCRIPTION	

A/E PROJECT NO):
CAD FILE NAME:	C7648T02
DESIGNED BY:	JGM
DRAWN BY:	ADD
EDITED BY:	ADD
CHECKED BY:	JGM


SCALE: AS SHOWN PLOT SCALE: 1:1 SHEET TITLE


REPLACE PUBLIC WORKS SHOP CG SECTOR NORTH CAROLINA ATLANTIC BEACH NORTH CAROLINA
PUBLIC WORKS SHOP
ARCHITECTURAL


DRAWING INDEX


	1 1		
	REVIEWED BY:	REVIEWED BY:	REVIEWED BY:
1	EUR HERSEY	B. VRANKAR	G.S. PLACZEK
	PROJECT ENG.	BRANCH CHIEF	TECH. DIRECTOR
	7.A. He	rly	
	J. A. HE	ALY, CAPT	02/01/10
	APPROVI	DATE	
	I PROJECT NUI	MRFR I DR	AWING NUMBER


05-C05124 7648-D DISCIPLINE/SHT NO T-02 SHEET 2 OF 28

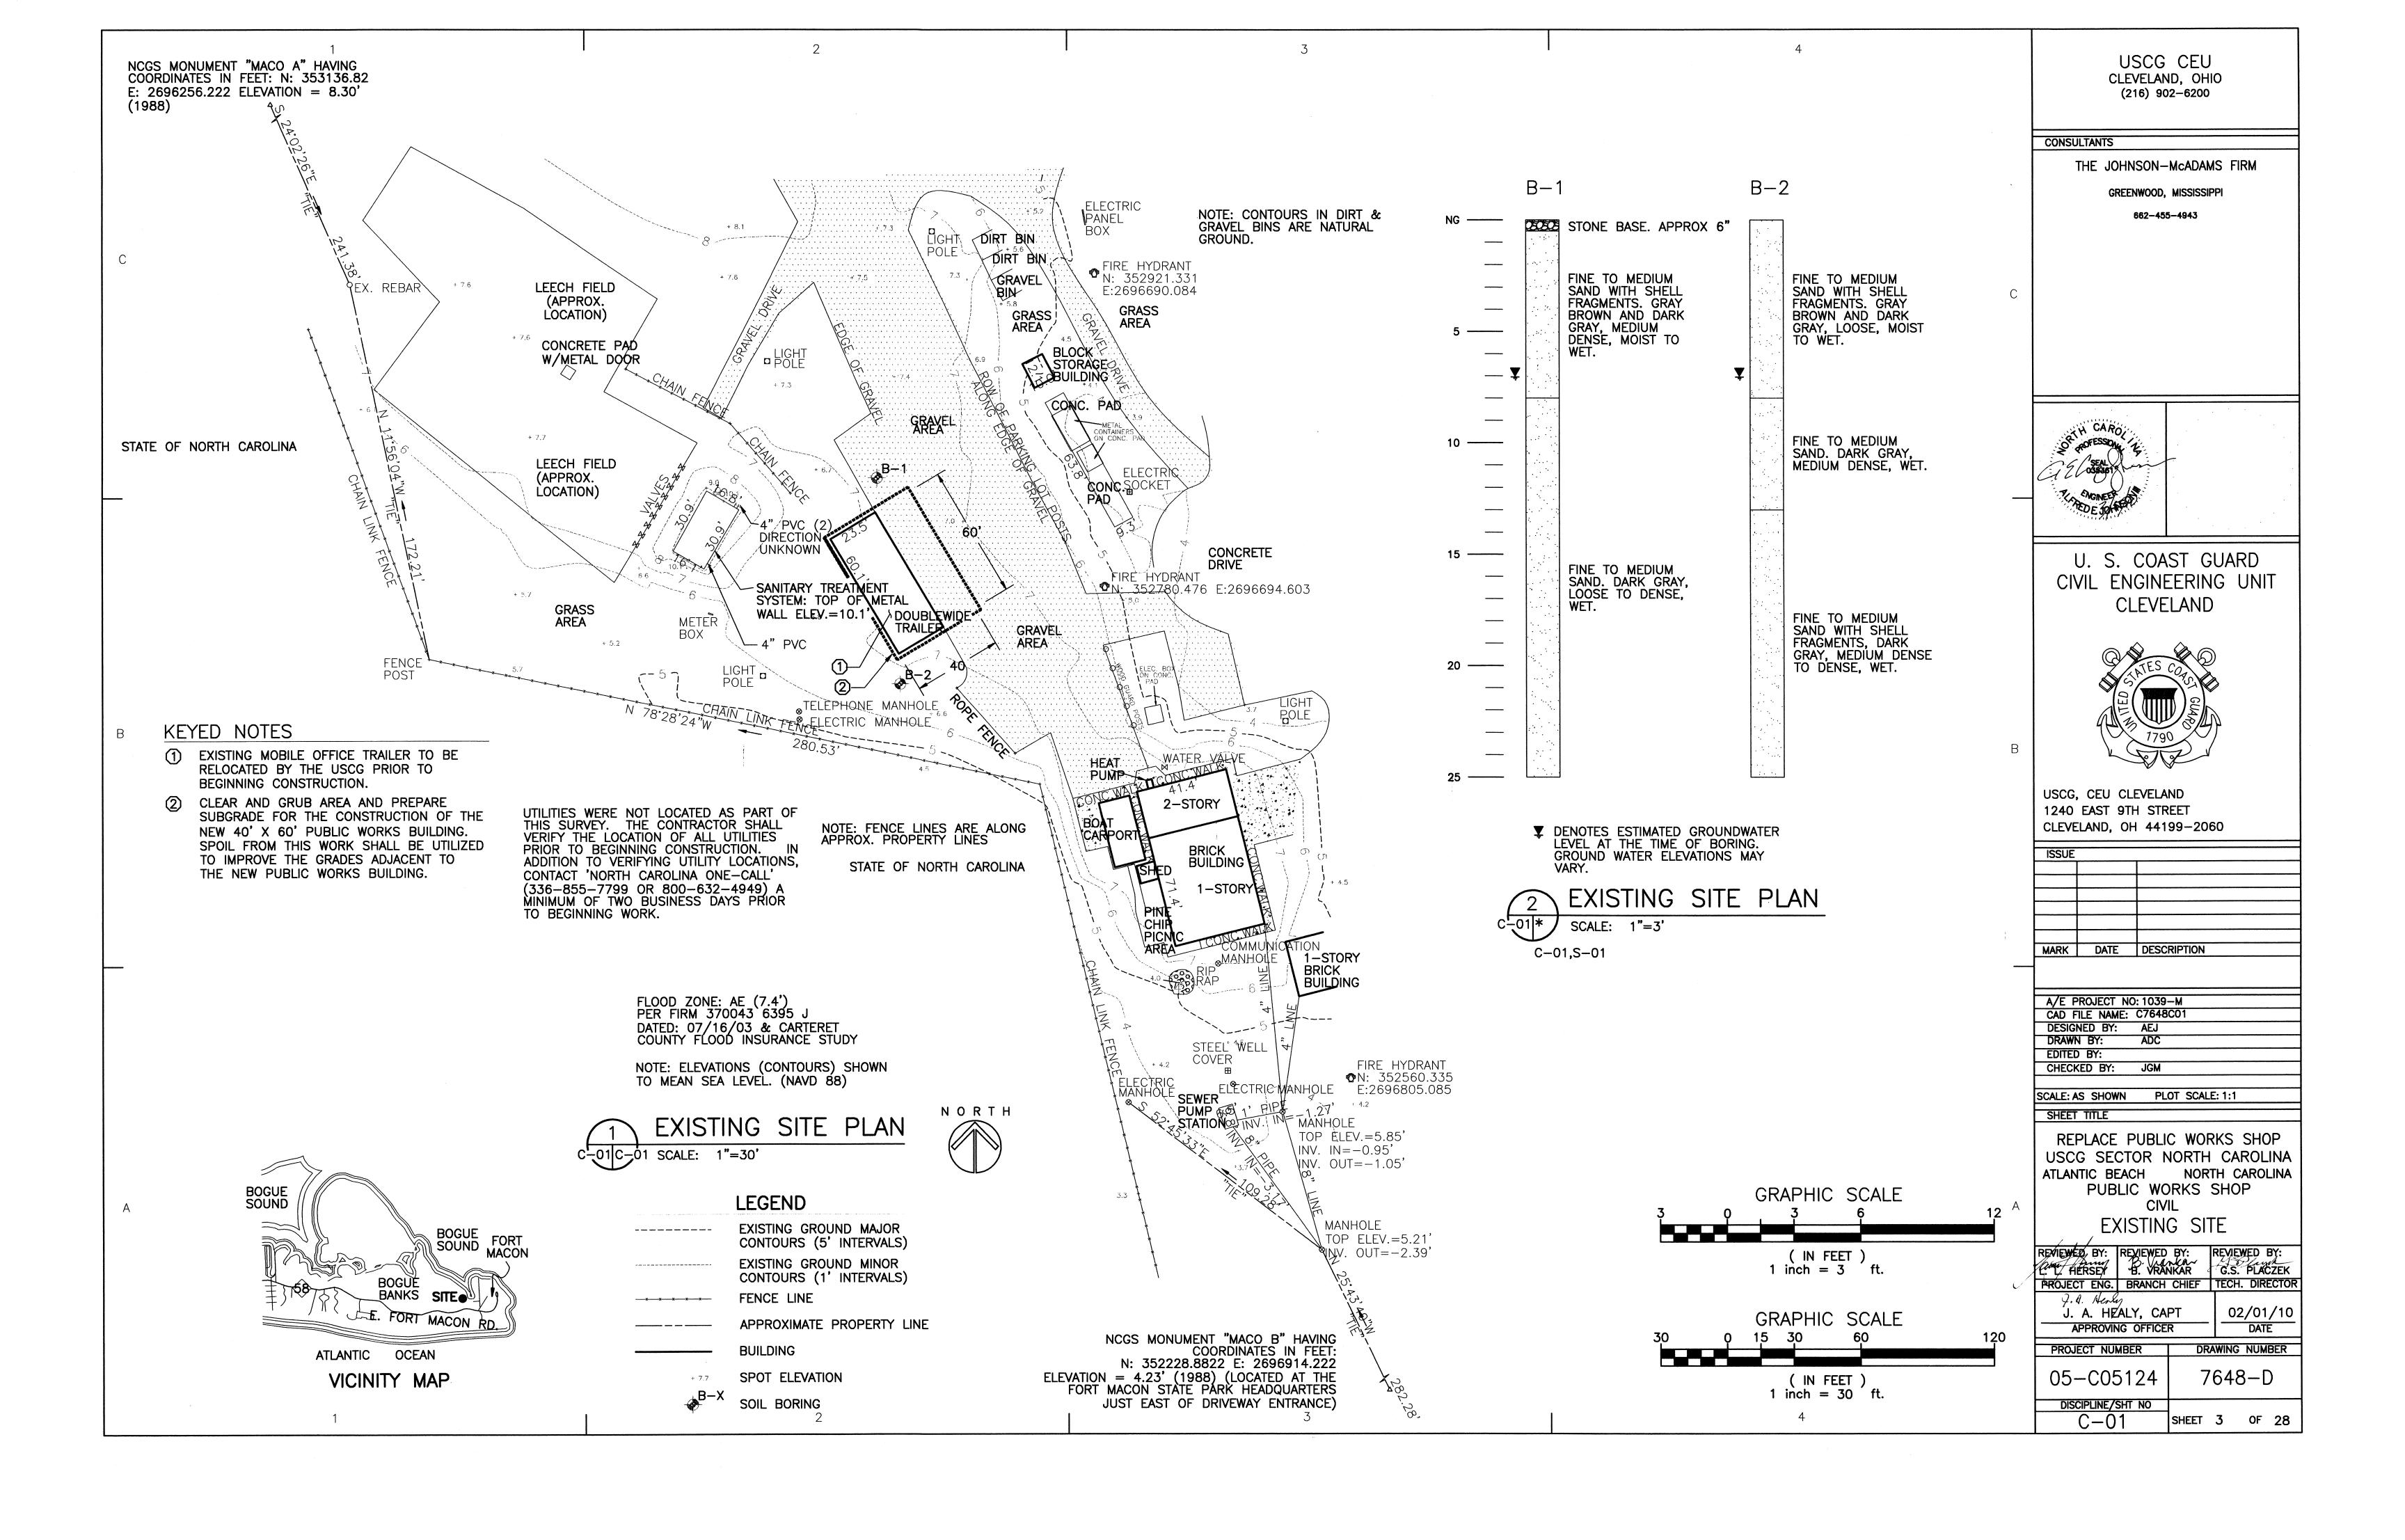


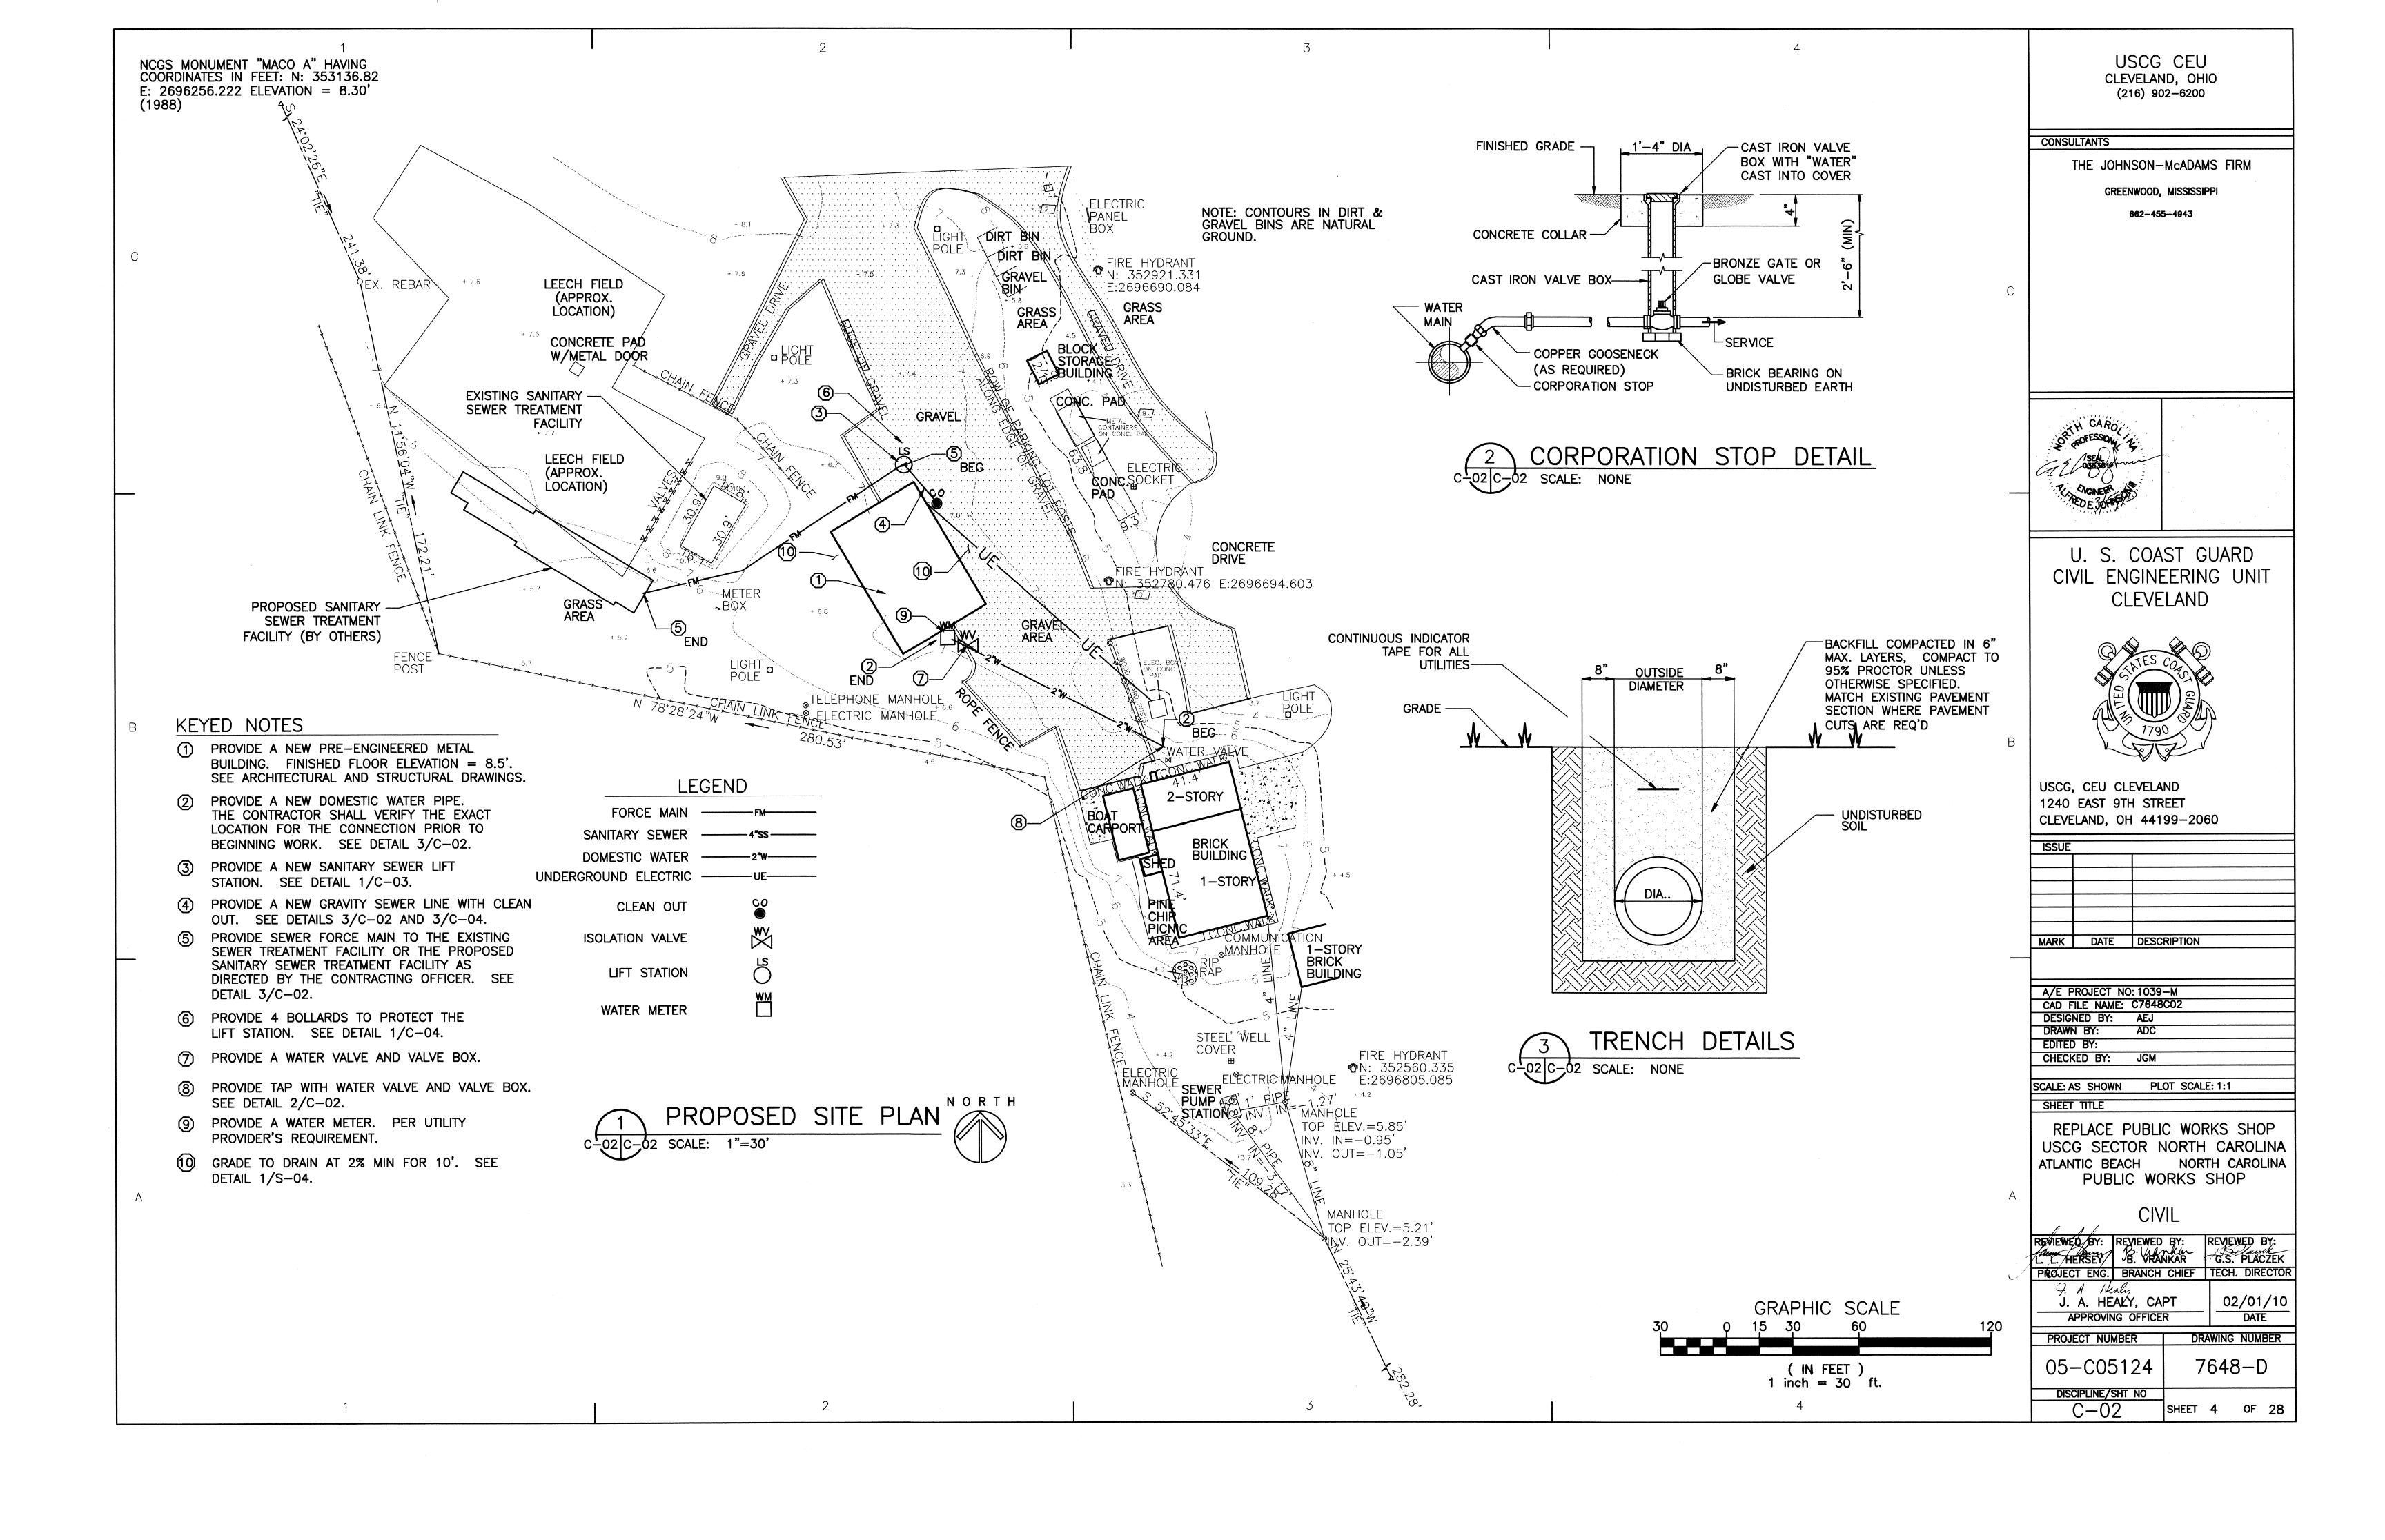

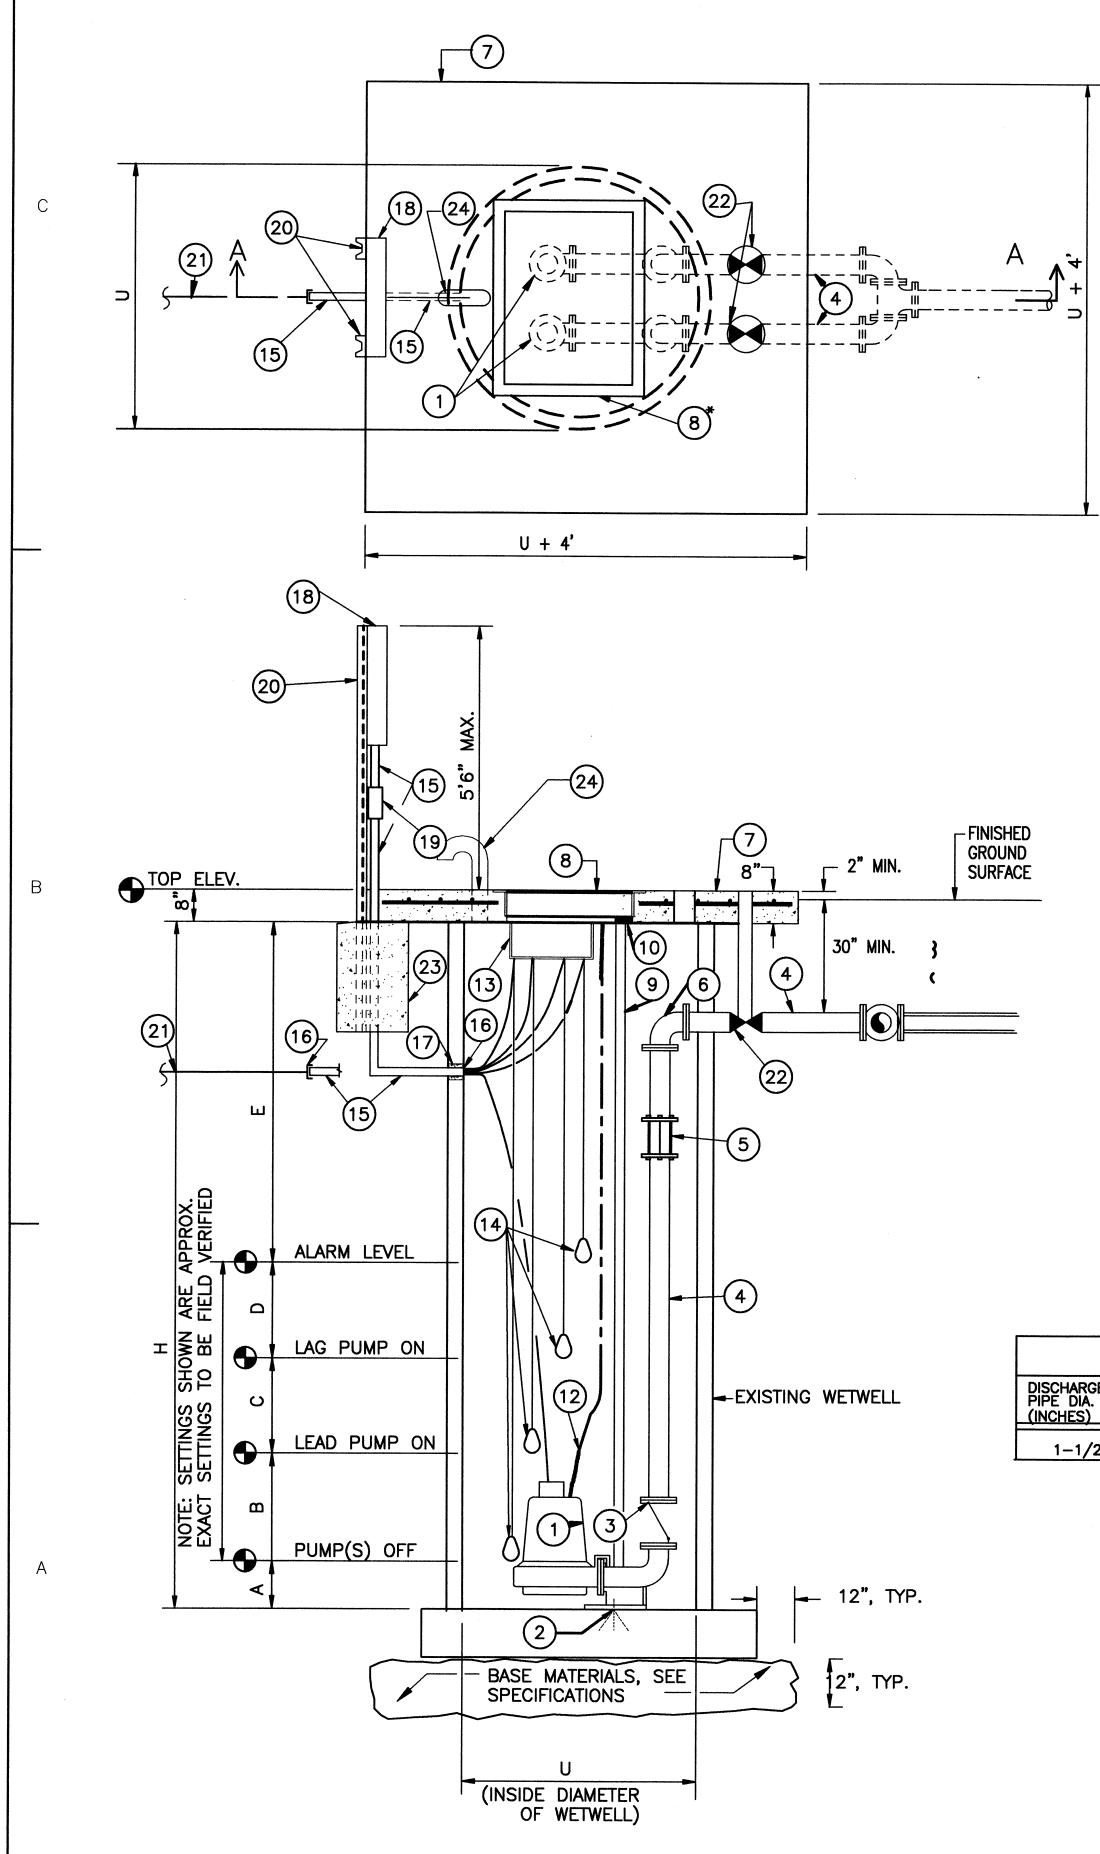

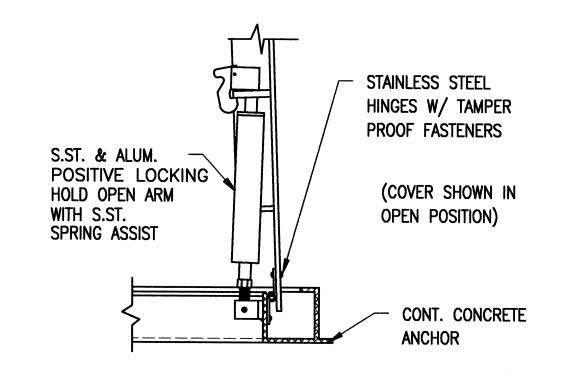

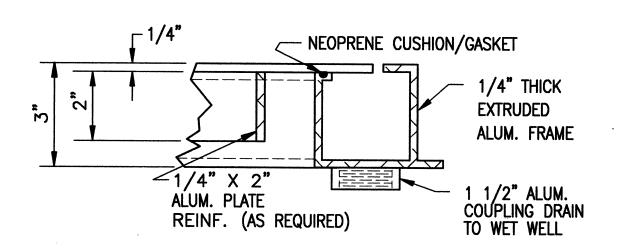

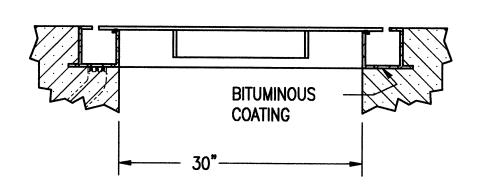

THE SINGLE LEAF ACCESS FRAME AND COVER SHALL HAVE A 1/4" THICK ONE-PIECE, MILL FINISH, EXTRUDED ALUMINUM CHANNEL FRAMÉ INCORPORATING A CONTINUOUS CONCRETE ANCHOR. A 1-1/2" DRAINAGE COUPLING SHALL BE LOCATED IN THE FRONT LEFT CORNER OF THE CHANNEL FRAME. A BITUMINOUS COATING SHALL BE APPLIED TO THE FRAME EXTERIOR WHERE IT WILL COME IN CONTACT WITH CONCRETE. DOOR PANEL SHALL BE 1/4" ALUMINUM DIAMOND PLATE, REINFORCED TO WITHSTAND A LIVE LOAD OF 300 LBS. PSF. DOOR SHALL OPEN TO 90° AND AUTOMATICALLY LOCK WITH A STAINLESS STEEL HOLD OPEN ARM WITH AN ALUMINUM RELEASE HANDLE. FOR EASE OF OPERATION, THE HOLD OPEN ARM SHALL INCORPORATE AN ENCLOSED STAINLESS STEEL COMPRESSION SPRING ASSISTED. DOOR SHALL CLOSE FLUSH WITH THE FRAME AND REST ON A BUILT-IN NEOPRENE CUSHION/GASKET. LIFTING HANDLE, HINGES AND ALL FASTENING HARDWARE SHALL BE STAINLESS STEEL. UNIT SHALL LOCK WITH A STAINLESS STEEL SLAM LOCK WITH REMOVABLE KEY. PROVIDE A WARRANTEE AGAINST DEFECTS IN MATERIAL AND/OR WORKMANSHIP FOR A PERIOD OF 10 YEARS.


3

SCALE: NONE

SEWAGE GRINDER PUMP STATION SCHEDULE													
DISCHARGÉ PIPE DIA. (INCHES)	FLOW (GPM)	TDH (FT)	НР	RPM	VOLTAGE	A (FT)	B (FT)	C (FT)	D (FT)	E (FT)	H (FT)	U (FT)	TOP ELEVATION
1-1/2*	27	20	2	3450	208V,3ø	1.0	2.0	2.0	2.0	3.0	10.0	4.0	8.5



2

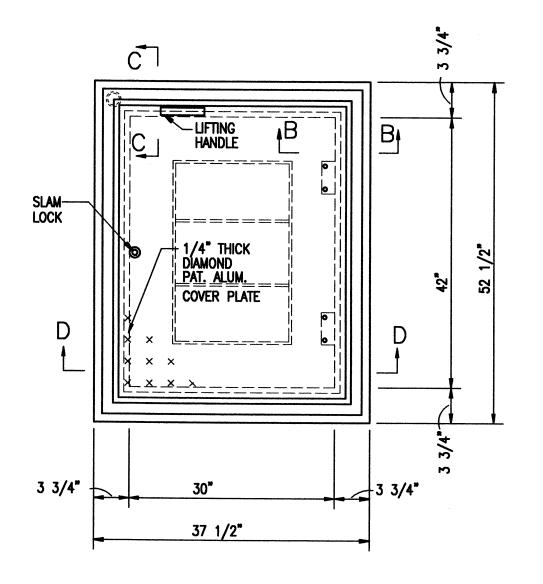


- 1) TWO NEW GRINDER PUMPS AS APPLICABLE, SEE SCHEDULE.
- NEW ANCHOR BOLTS AS REQUIRED BY PUMP MANUFACTURER.
- 3) NEW CHECK VALVE
- -) NEW DISCHARGE PIPE, GALVANIZED SCHEDULE 40.
- 5) NEW DRESSER COUPLING AS REQUIRED.
- NEW 90 DEGREE FLANGED ELL.
- 7 NEW 8" CONCRETE TOP SLAB. U+4'x U+4' SQUARE WITH #6 BARS AT 8 INCHES ON CENTER EACH WAY.
- (8) NEW ACCESS DOOR. SEE DETAIL, THIS DWG.
- 9) NEW GUIDE RAILS AS REQUIRED BY PUMP MANUFACTURER.
- (10) NEW UPPER GUIDE BAR BRACKET.
- 11 NOT USED
- (12) NEW LIFTING CHAIN AS REQUIRED BY PUMP MANUFACTURER.
- 13 NEW CABLE HOLDER.
- (14) NEW FLOAT SWITCHES.
- NEW PVC COATED GALVANIZED RIGID STEEL CONDUIT. SIZE AS REQUIRED FOR CONDUCTORS AND/OR FLOAT CONTROL CABLES.
- (16) NEW CONDUIT SEAL.
- (17) NEW CONCRETE GROUT AROUND CONDUIT PENETRATION.
- 18 NEW NEMA 3R PUMP CONTROL PANEL.
- NEW JUNCTION BOX. (NOTE: ALL PUMP POWER CORDS AND FLOAT CONTROL CABLES SHALL HAVE SUFFICIENT LENGTH TO REACH FROM THIS JUNCTION BOX TO THE PUMP AND/OR FLOAT SWITCH WITHOUT BEING SPLICED.)
- NEW C6X8.2 GALVANIZED STEEL CONTROL PANEL SUPPORT. HOT DIP GALVANIZE AFTER FABRICATION.
- (21) NEW UNDERGROUND POWER SUPPLY, SEE ELECTRICAL DWGS
- (22) NEW GATE VALVE W/VALVE BOX
- NEW 24" DIA.x30" DEEP CONCRETE FOOTING FOR NEW CONTROL PANEL SUPPORT.
- (24) NEW 4" DIA. WELDED STEEL VENT. GALVANIZE AFTER FABRICATION.

USCG CEU CLEVELAND, OHIO (216) 902-6200

CONSULTANTS

THE JOHNSON-McADAMS FIRM
GREENWOOD, MISSISSIPPI

662-455-4943

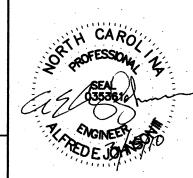

U. S. COAST GUARD CIVIL ENGINEERING UNIT CLEVELAND



USCG, CEU CLEVELAND 1240 EAST 9TH STREET CLEVELAND, OH 44199-2060

	T
DATE	DESCRIPTION
DATE	DESCRIPTION
DAIL	DESCRIPTION
	DATE

A/E PROJECT NO: 1039-M
CAD FILE NAME: C7648C03
DESIGNED BY: AEJ
DRAWN BY: ADC
EDITED BY:
CHECKED BY: JGM

SCALE: AS SHOWN PLOT SCALE: 1:1
SHEET TITLE

REPLACE PUBLIC WORKS SHOP
USCG SECTOR NORTH CAROLINA
ATLANTIC BEACH NORTH CAROLINA
PUBLIC WORKS SHOP

LIFT STATION DETAIL

REVIEWED BY: REVIEWED BY: REVIEWED BY:

L. HERSEY B. VRANKAR G.S. PLACZEK

PROJECT ENG. BRANCH CHIEF TECH. DIRECTOR

J. A. HEALY, CAPT 02/01/10


APPROVING OFFICER DRAWING NUMBER

PROJECT NUMBER DRAWING NUMBER


05-C05124 7648-D

DISCIPLINE/SHT NO


C-03 SHEET 5 OF 28

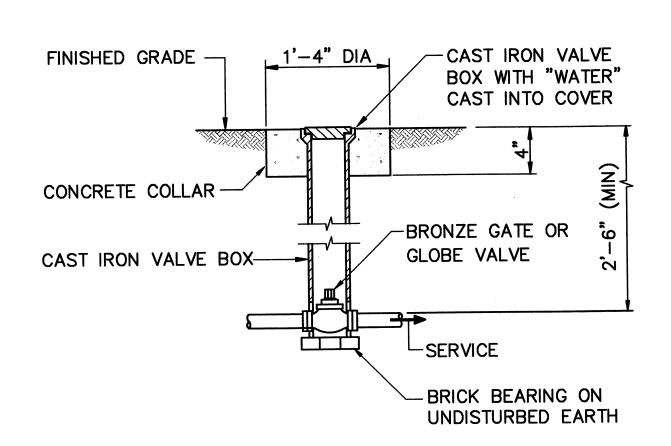




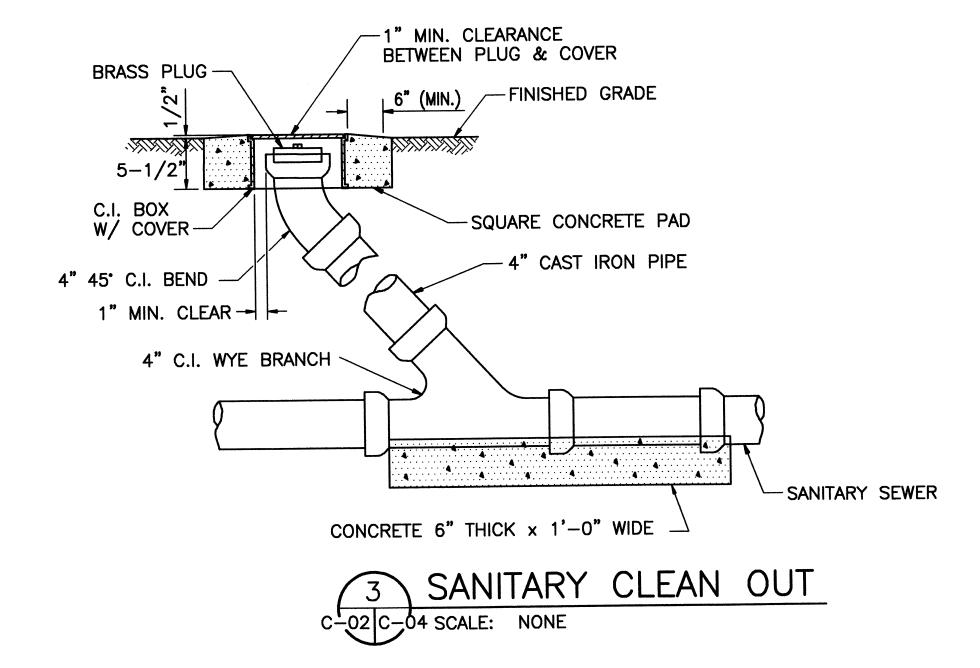

2

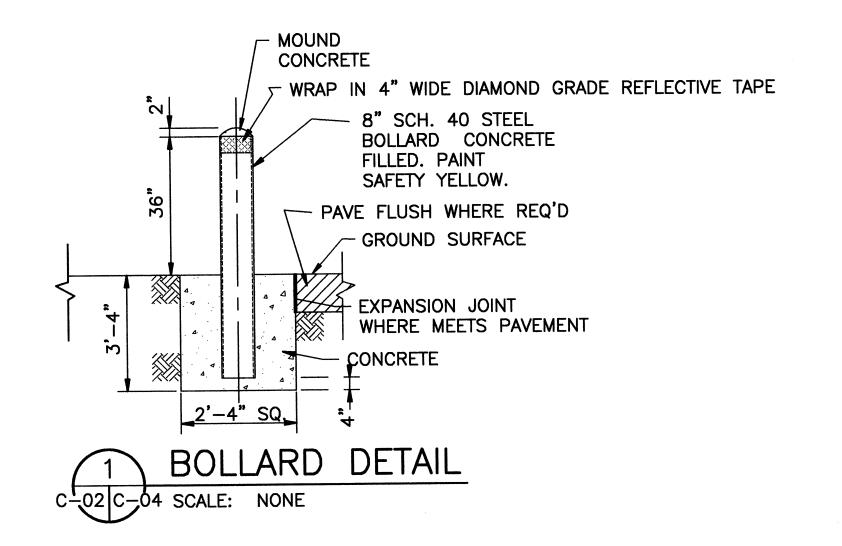


NOTE: WHEN 18" VERTICAL SEPARATION CANNOT BE MAINTAINED, JOINTS SHALL BE LOCATED SUCH THAT THEY ARE EQUAL DISTANCE BEFORE AND AFTER CROSSING.

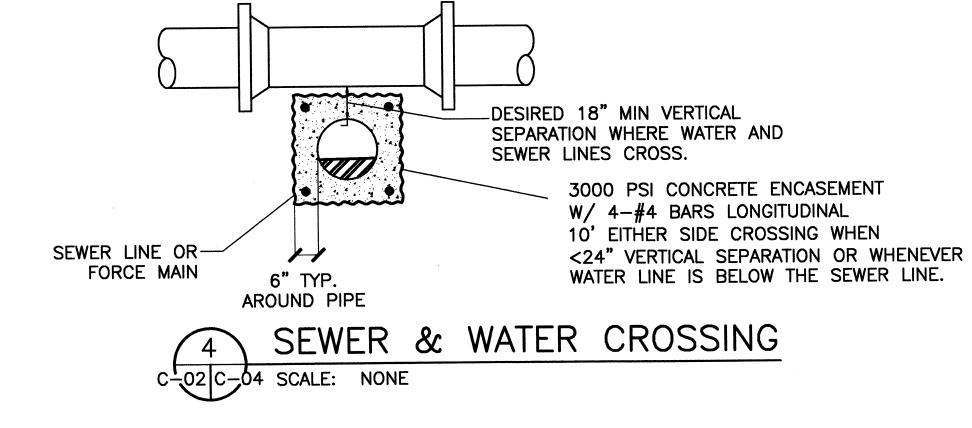

USCG CEU CLEVELAND, OHIO (216) 902-6200

CONSULTANTS

THE JOHNSON-McADAMS FIRM
GREENWOOD, MISSISSIPPI
662-455-4943

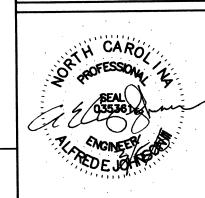

U. S. COAST GUARD CIVIL ENGINEERING UNIT CLEVELAND



USCG, CEU CLEVELAND 1240 EAST 9TH STREET CLEVELAND, OH 44199-2060

l	ISSUE	·	
I			
l			
ı			
	MARK	DATE	DESCRIPTION

A/E PROJECT NO: 1039—M

CAD FILE NAME: C7648C04

DESIGNED BY: AEJ

DRAWN BY: ADC

EDITED BY:

CHECKED BY: JGM

SCALE: AS SHOWN PLOT SCALE: 1:1

SCALE: AS SHOWN PLOT SCALE: 1:
SHEET TITLE

SHEET TITLE

REPLACE PUBLIC WORKS SHOP
USCG SECTOR NORTH CAROLINA
ATLANTIC BEACH NORTH CAROLINA
PUBLIC WORKS SHOP
CIVIL

CIVIL DETAILS

REVIEWED BY:	REVIEWED BY:			
 L. HERSEY	REVIEWED 13. VIAN B. VRAN	IKAR	G.S. PLACZE	
PRØJECT ENG.	BRANCH	CHIEF	TECH. DIRECT	OF
J. A. HE APPROVIN	02/01/1 DATE	0		
PROJECT NUI	MBER	DR	AWING NUMBER	₹
05 006		7	648_D	

PRE-ENGINEERED METAL BUILDING AND STRUCTURAL NOTES:

- 1. THE BUILDING SHALL BE PRE-ENGINEERED BUILDING AS SPECIFIED IN SPECIFICATION SECTION 13 34 19, "METAL BUILDING SYSTEMS". THE BUILDING SHALL BE A MANUFACTURER'S STANDARD PREFABRICATED METAL STRUCTURE OF THE INSIDE AREA SHOWN. OVERALL DIMENSIONS AND CONSTRUCTION DETAILS MAY VARY TO SUIT MANUFACTURER'S STANDARD DESIGN.
- 2 THE BUILDING SHALL BE DESIGNED AND FABRICATED ACCORDING TO AISC (AMERICAN INSTITUTE OF STEEL CONSTRUCTION) AND AISI (AMERICAN IRON AND STEEL INSTITUTE) LATEST SPECIFICATIONS. THE DIMENSIONAL TOLERANCES OUTLINED IN THE AWS (AMERICAN WELDING SOCIETY) CODE UNDER WORKMANSHIP AND THE TOLERANCES APPLICABLE TO ROLL FORM STEEL UNDER THE AISC "STANDARD MILL PRACTICE" SECTION SHALL BE REQUIRED IN THE FABRICATION OF THE STEEL BUILDING FRAMES.
- 3. A COMPLETE DESIGN ANALYSIS SHOWING ALL CALCULATIONS FOR THE RIGID FRAMES, GIRTS, AND PURLINS, AND A LAYOUT OF ANCHOR BOLTS AND OTHER EMBEDDED ITEMS SHALL BE SUBMITTED FOR APPROVAL WITH THE SHOP DRAWINGS. SHOP DRAWINGS SHALL INCLUDE DETAILS OF ALL MAIN MEMBERS, TYPICAL CONNECTIONS (SHOWING BOLT HOLES AND WELDS), AND ERECTION DRAWINGS.
- 4. THE BUILDING SHALL BE DESIGNED TO SUPPORT ALL FLOORS, DOORS, EQUIPMENT AND ALL OTHER DEVICES. ADDITIONAL STRUCTURAL STEEL, GIRTS OR PURLINS SHALL BE PLACED IN CONVENIENT LOCATIONS FOR ATTACHMENT OF ALL EQUIPMENT AND DEVICES.
- 5. CROSS BRACING SHALL NOT BE USED WHERE POTENTIAL CONFLICTS WITH DOORS, WINDOWS, OR BUILDING APPURTENANCES COULD ARISE
- 6. THE FOUNDATIONS SHOWN ARE ESTIMATES FOR THE BUILDING TYPE SHOWN ON THE DRAWINGS AND ARE TO BE USED AS A GUIDE FOR THE BUILDING SUPPLIED. THESE FOUNDATIONS ARE SIZED FOR THE VALUES SHOWN IN THE "FOUNDATION REACTION DIAGRAM". THE CONTRACTOR SHALL DESIGN THE FOUNDATIONS FOR THE SPECIFIC LOADS FOR THE BUILDING SUPPLIED. ADDITIONAL SUPPORT MAY BE REQUIRED IN AREAS OF TUBULAR STEEL COLUMNS.
- 7. THE CONTRACTOR SHALL USE IN HIS DESIGN THE BASIC CRITERIA SHOWN BY THIS DRAWING, SUCH AS SLAB THICKNESS, CONTROL JOINTS. DESIGN LOADS AND MINIMUM DEPTH OF FOOTING.
- 8. FOOTINGS SHALL BE SIZED FOR AN ALLOWABLE SOIL BEARING PRESSURE OF 2000 PSF. THE ALLOWABLE SOIL PRESSURE IS BASED UPON A GEOTECHNICAL REPORT PREPARED BY TERRACON CONSULTANTS, INC. DATED MARCH 16TH, 2009.
- DESIGN THE BUILDING SYSTEM FOR THE LIVE LOADS OR SNOW LOADS (WHICHEVER IS GREATER) INDICATED AND A COLLATERAL LOAD OF 5 PSF IN ADDITION TO THE BUILDING DEAD LOADS, WIND LOADS AND SEISMIC LOADS. PARAMETERS FOR THE DEVELOPMENT OF THE SNOW, WIND AND SEISMIC LOADS ARE LISTED IN THE DESIGN LOADS ON THIS SHEET. ROOF PURLINS SHALL BE DESIGNED FOR AN ADDITIONAL CONCENTRATED LIVE LOAD OF 300 POUNDS LOCATED ANYWHERE ALONG THE LENGTH OF THE PURLIN.

DESIGN LOADS

USE ASCE 7-05 FOR ALL BUT SEISMIC. USE TI 809-04 FOR SEISMIC

AS REQ'D BY MANUFACTURER DEAD LOAD

5.0 PSF (TOTAL) COLLATERAL LOADS 20.0 PSF ROOF LIVE LOAD 20.0 PSF FRAME LIVE LOAD 0.0 PSF GROUND SNOW LOAD SNOW EXPOSURE FACTOR N/A N/A THERMAL FACTOR

IMPORTANCE FACTOR, SNOW N/A 0.0 PSF ROOF SNOW LOAD

140 MPH WIND SPEED WIND EXPOSURE ENCLOSED ENCLOSURE CLASSIFICATION

IMPORTANCE FACTOR, WIND SEISMIC HAZARD USE GROUP SEISMIC DESIGN CATEGORY LIFE SAFETY SEISMIC PERFORMANCE LEVEL

SEISMIC SITE CLASSIFICATION

10. ALL CONCRETE SHALL CONFORM TO ACI (AMERICAN CONCRETE INSTITUTE) 301 AND SHALL DEVELOP A MINIMUM COMPRESSIVE STRENGTH (f'c) OF 3500 PSI @ 28 DAYS.

11. CONCRETE COVER ON REINFORCEMENT SHALL BE AS FOLLOWS: CONCRETE CAST AGAINST EARTH 3 INCHES 2 INCHES CONCRETE EXPOSED TO EARTH OR WEATHER 2 INCHES CONCRETE SLABS

- 12. REINFORCING STEEL SHALL BE ASTM A 615, GRADE 60 FOR BARS OR ASTM A 185 FOR WELDED WIRE FABRIC. REINFORCING STEEL SHALL BE LAPPED AS SPECIFIED IN ACI 318-02.
- 13. GROUT SHALL BE NON-SHRINK WITH COMPRESSIVE STRENGTH (f'c) OF 4500 PSI @ 28 DAYS.
- 14. PROVIDE VAPOR BARRIER (ASTM E1745) OVER A 4 INCH CAPILLARY (WASHED STONE (NCDOT NO. 57 OR 67) BARRIER UNDER SLABS.
- 15. PROVIDE A FLUSH MOUNTED GIRT SYSTEM TO MAXIMIZE USABLE FLOOR SPACE.

FOOTING SCHEDULE MARK | LENGTH | WIDTH | THICKNESS | REINFORCEMENT 7'-0" | 7'-0" | (8) #6, E.W. NOTE: UNLESS OTHERWISE NOTED. THE TOPS OF ALL FOOTINGS TO BE 26" BELOW FINISHED FLOOR ELEVATION.

USCG CEU CLEVELAND, OHIO (216) 902-6200

CONSULTANTS

THE JOHNSON-McADAMS FIRM

GREENWOOD, MISSISSIPPI 662-455-4943

CARO 2 ROFESSION CAGINEER

> U. S. COAST GUARD CIVIL ENGINEERING UNIT CLEVELAND



USCG, CEU CLEVELAND 1240 EAST 9TH STREET CLEVELAND, OH 44199-2060

MARK	DATE	DESCRIPTION

CAD FILE NAME: C7648S01 DESIGNED BY: AEJ DRAWN BY: EDITED BY: CHECKED BY: JGM SCALE: AS SHOWN PLOT SCALE: 1:1

SHEET TITLE

A/E PROJECT NO: 1039-M

REPLACE PUBLIC WORKS SHOP USCG SECTOR NORTH CAROLINA NORTH CAROLINA ATLANTIC BEACH PUBLIC WORKS SHOP STRUCTRURAL

STRUCTURAL REQUIREMENTS

REVIEWED BY: REVIEWED BY: REVIEWED BY:

L. L. HERSEY

B. VRANKAR

G.S. PLACZEK PROJECT ENG. BRANCH CHIEF TECH. DIRECTOR J. A. Henly J. A. HEALY, CAPT 02/01/10 APPROVING OFFICER DATE

PROJECT NUMBER DRAWING NUMBER 05-C05124 7648-D DISCIPLINE/SHT NO SHEET 7 OF 28 S - 01

ABBREVIATIONS

EFFECTIVE PEAK VELOCITY EFFECTIVE PEAK VELOCITY RELATED ACCELERATION ASCE AMERICAN SOCIETY OF CIVIL ENGINEERS

DEAD LOAD

SERVICE LOAD

HORIZONTAL

HORIZONTAL LEFT HORIZONTAL RIGHT

1000 POUNDS

LIVE ROOF LOAD **VERTICAL**

VERTICAL LEFT VERTICAL RIGHT

WIND LOAD

SUMMARY OF GEOTECHNICAL REPORT FINDINGS:

A. STRUCTURAL BACKFILL/FILL UNIFORMLY COMPACTED TO A MINIMUM OF 95% ASTM D 698.

SOIL SHOULD BE CLASSIFIED AS SM, SC, SP OR SW AS DEFINED BY THE UNIFIED SOIL CLASSIFICATION SYSTEM.


B. FOOTING SIZES

B.1. COLUMN FOOTINGS = 24 INCHES (MIN). B.2. WALL FOOTINGS = 16 INCHES (MIN).

C. SUBGRADE

C.1. MODULUS OF SUBGRADE REACTION (k) = 150 POUNDS PER CUBIC INCH (6 PASSES FOLLOWED BY 3 PASSES IN A PERPENDICULAR DIRECTION).

C.2. COMPACT WITH MEDIUM WEIGHT VIBRATORY ROLLER. C.3. PROOF ROLE WITH LOADED TANDEM-AXEL DUMP TRUCK.

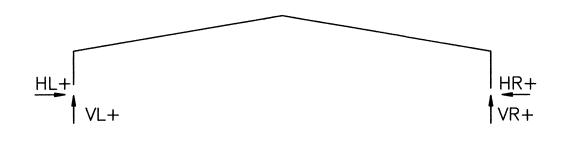

MAXI	MUM ESTIM	IATED REAC	CTIONS	
HL	VL	HR	VR	
-10.6	* -17.5		* -17.5	
(1) ALL VAL	UES ARE IN KI	PS (1000 LBS).	

- (2) VALUES WITH (-) SIGN ACT IN OPPOSITE DIRECTION OF ARROWS IN DIAGRAMS
- (*) LINE 1 & 3 = 24.2 AND 2 = 30.0

ABBREVIATIONS

HORIZONTAL HL HORIZONTAL LEFT HR HORIZONTAL RIGHT

S-03/

(3)--

- VERTICAL VL VERTICAL LEFT
- VR VERTICAL RIGHT

FOUNDATION REACTION DIAGRAM (MAX. VALUES) NOT TO SCALE

GEOTECHNICAL ENGINEERING (SOIL BORING) REPORT:


FOR SOIL BORING INFORMATION SEE GEOTECHNICAL ENGINEERING REPORT 'USCG NEW PUBLIC WORKS BUILDING' PREPARED BY TERRACON CONSULTANTS, INC. DATED MARCH 16TH, 2009 INCLUDED WITH SUBMITTAL DOCUMENTS. SEE SHEET C-1 FOR LOCATIONS.



S-04/

60'-0"



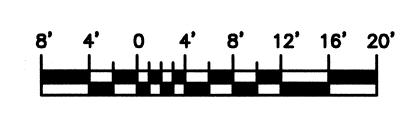

SCALE: 1/8" = 1'-0"


JOINT LEGEND

----- CONTROL JOINT


2 .

S-02

3

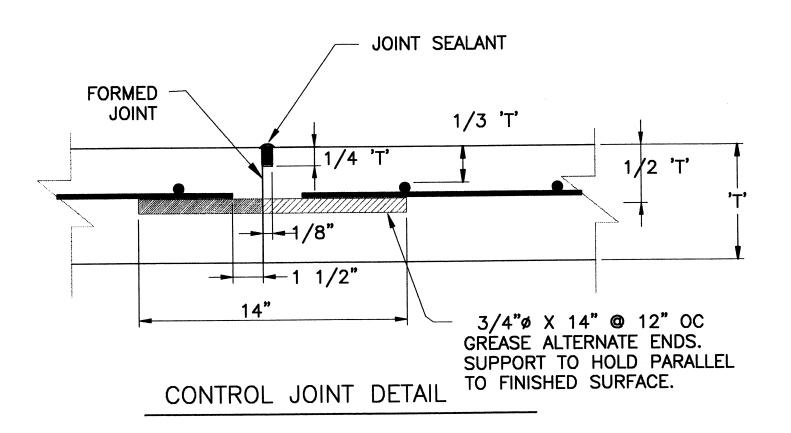



TYPICAL JOINT DETAILS S-01 S-02 SCALE: NONE

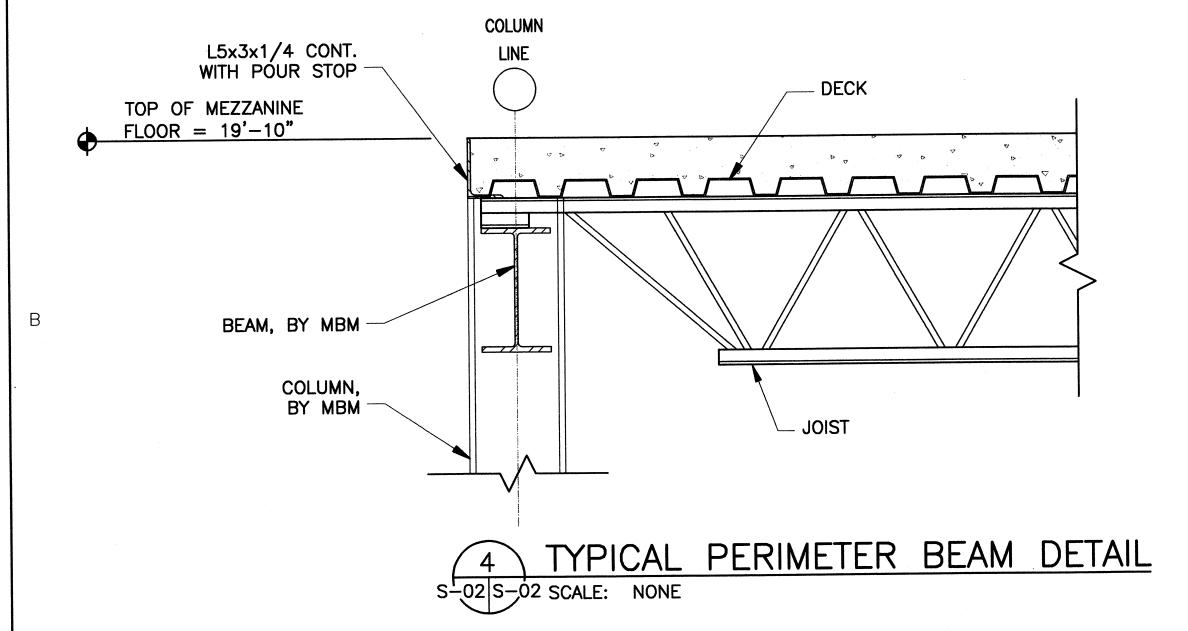

GENERAL NOTES:


- 1. CAPILLARY BARRIER SHALL BE A COARSE
 AGGREGATE WITH #57 GRADATION OR APPROVED
 EQUAL.
- 2. VAPOR RETARDERS SHALL MEET THE REQUIREMENTS OF ASTM E1745. ALL LAPS SHALL BE SEALED IN ACCORDANCE WITH THE MANUFACTURERS WRITTEN INSTRUCTIONS.
- 3. CONCRETE SHALL OBTAIN A MINIMUM 3500 PSI STRENGTH AT 28 DAYS. CONCRETE SLUMP SHALL NOT EXCEED 5" WITHOUT THE WRITTEN APPROVAL OF THE CONTRACTING OFFICER.

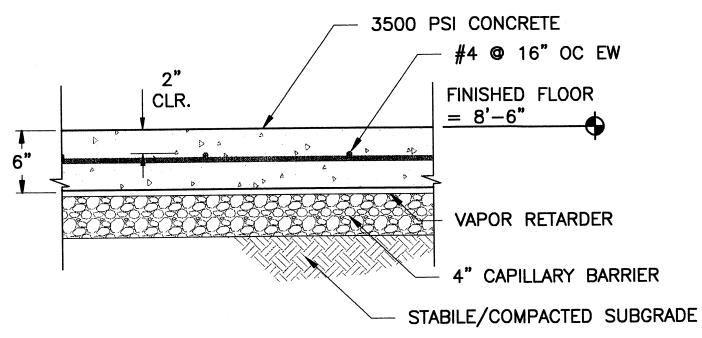

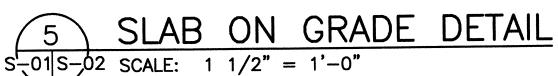

GENERAL NOTES:


- 1. CONCRETE FLOOR SLAB ON COMPOSITE STEEL DECK.
- 2. CONTINUOUS THREE SPAN MINIMUM.
- 3. GALVANIZED UNDER DECK.
- 4. PROVIDE CLOSURES, LAPS, POUR STOPS AND FASTENERS PER THE MANUFACTURER'S WRITTEN REQUIREMENTS.

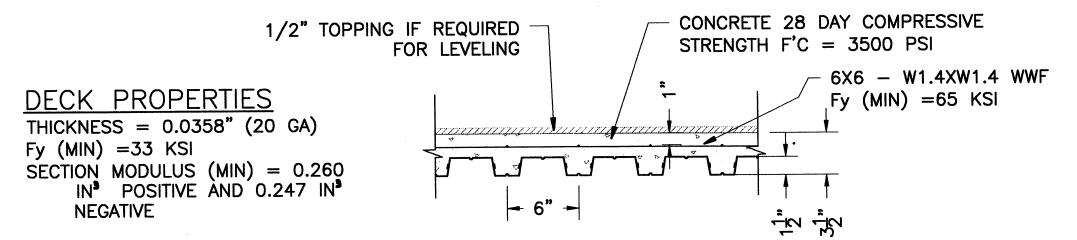


2 ELEVATED SLAB DETAIL s-02|s-02| SCALE: 1 1/2" = 1'-0"


ANTICIPATED BEAM REACTION TABLE (ASD)				
BEAM	VERTICAL REACTION	MOMENT		
W16X89	30.5 K	0 K-FT		
W12X65	15.5 K	0 K-FT		
W10X26	4.5 K	0 K-FT		

LOADS AND CONNECTIONS FOR THE MEZZANINE BEAMS TO THE PEMB STRUCTURE SHALL BE VERIFIED AND DESIGNED BY MANUFACTURER'S REGISTERED PROFESSIONAL ENGINEER UTILIZING, AT A MINIMUM, THE LOADS FROM THE BEAM REACTION TABLE. THESE DESIGNS SHALL BE SEALED BY THE PROFESSIONAL ENGINEER AND SUBMITTED AS PART OF THE BUILDING SHOP DRAWINGS FOR APPROVAL BY THE CONTRACTING OFFICER PRIOR TO BEGINNING FABRICATION.

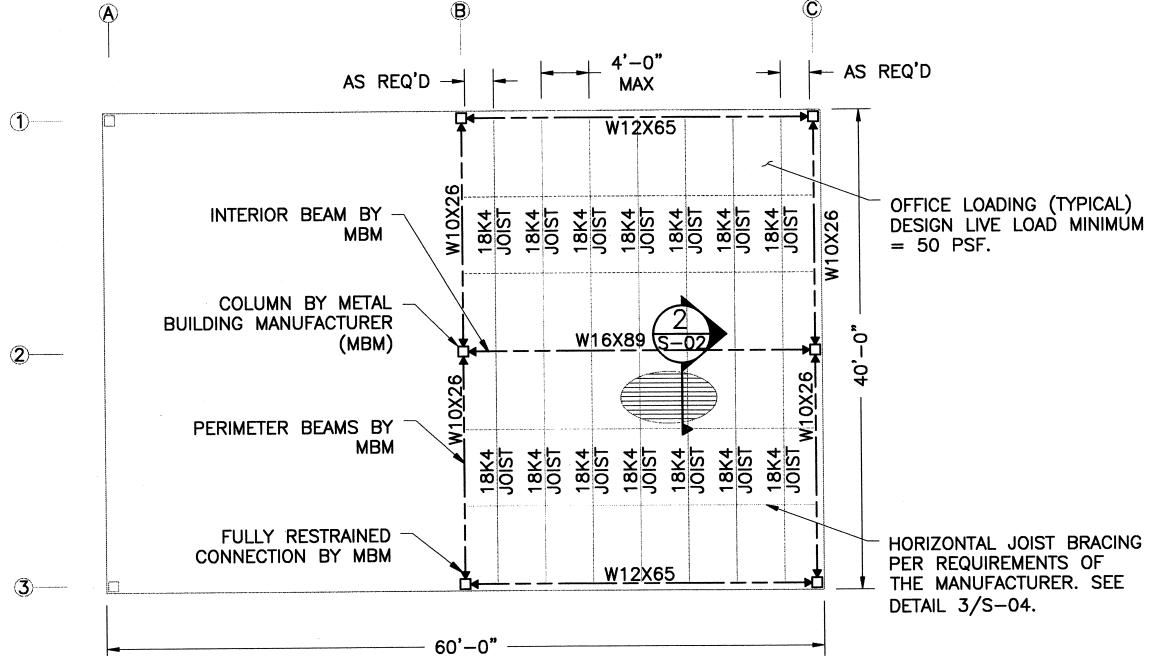

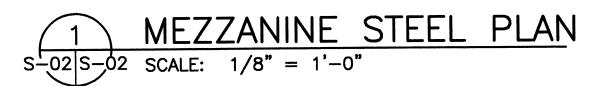



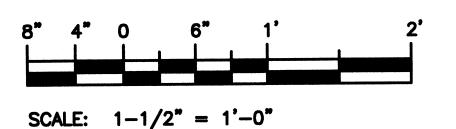




SCALE: 1/8" = 1'-0"

USCG CEU CLEVELAND, OHIO (216) 902-6200

CONSULTANTS

THE JOHNSON-McADAMS FIRM GREENWOOD, MISSISSIPPI

662-455-4943

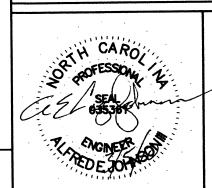

U. S. COAST GUARD CIVIL ENGINEERING UNIT CLEVELAND



USCG, CEU CLEVELAND 1240 EAST 9TH STREET CLEVELAND, OH 44199-2060

1				
	MARK	DATE	DESCRIPTION	
	A/E F	PROJECT NO	D: 1039-M	
	CAD F	TLE NAME:	C7648S02	
	DESIG	NED BY:	AEJ	
	DRAW	N BY:	ADC	
	EDITE	BY:		
	CHECK	KED BY:	JGM	

SCALE: AS SHOWN PLOT SCALE: 1:1

SHEET TITLE

ISSUE

REPLACE PUBLIC WORKS SHOP
USCG SECTOR NORTH CAROLINA
ATLANTIC BEACH NORTH CAROLINA
PUBLIC WORKS SHOP
STRUCTURAL
STRUCTURAL DETAILS

REVIEWED BY: REVIEWED BY: REVIEWED BY:

HERSEY B. VRANKAR G.S. PLACZEK

PROJECT ENG. BRANCH CHIEF TECH. DIRECTOR

J. A. HEALY, CAPT


APPROVING OFFICER


DRAWING NUMBER

 PROJECT NUMBER
 DRAWING NUMBER


 05-C05124
 7648-D


 DISCIPLINE/SHT NO
S-02
 SHEET 8 OF 28

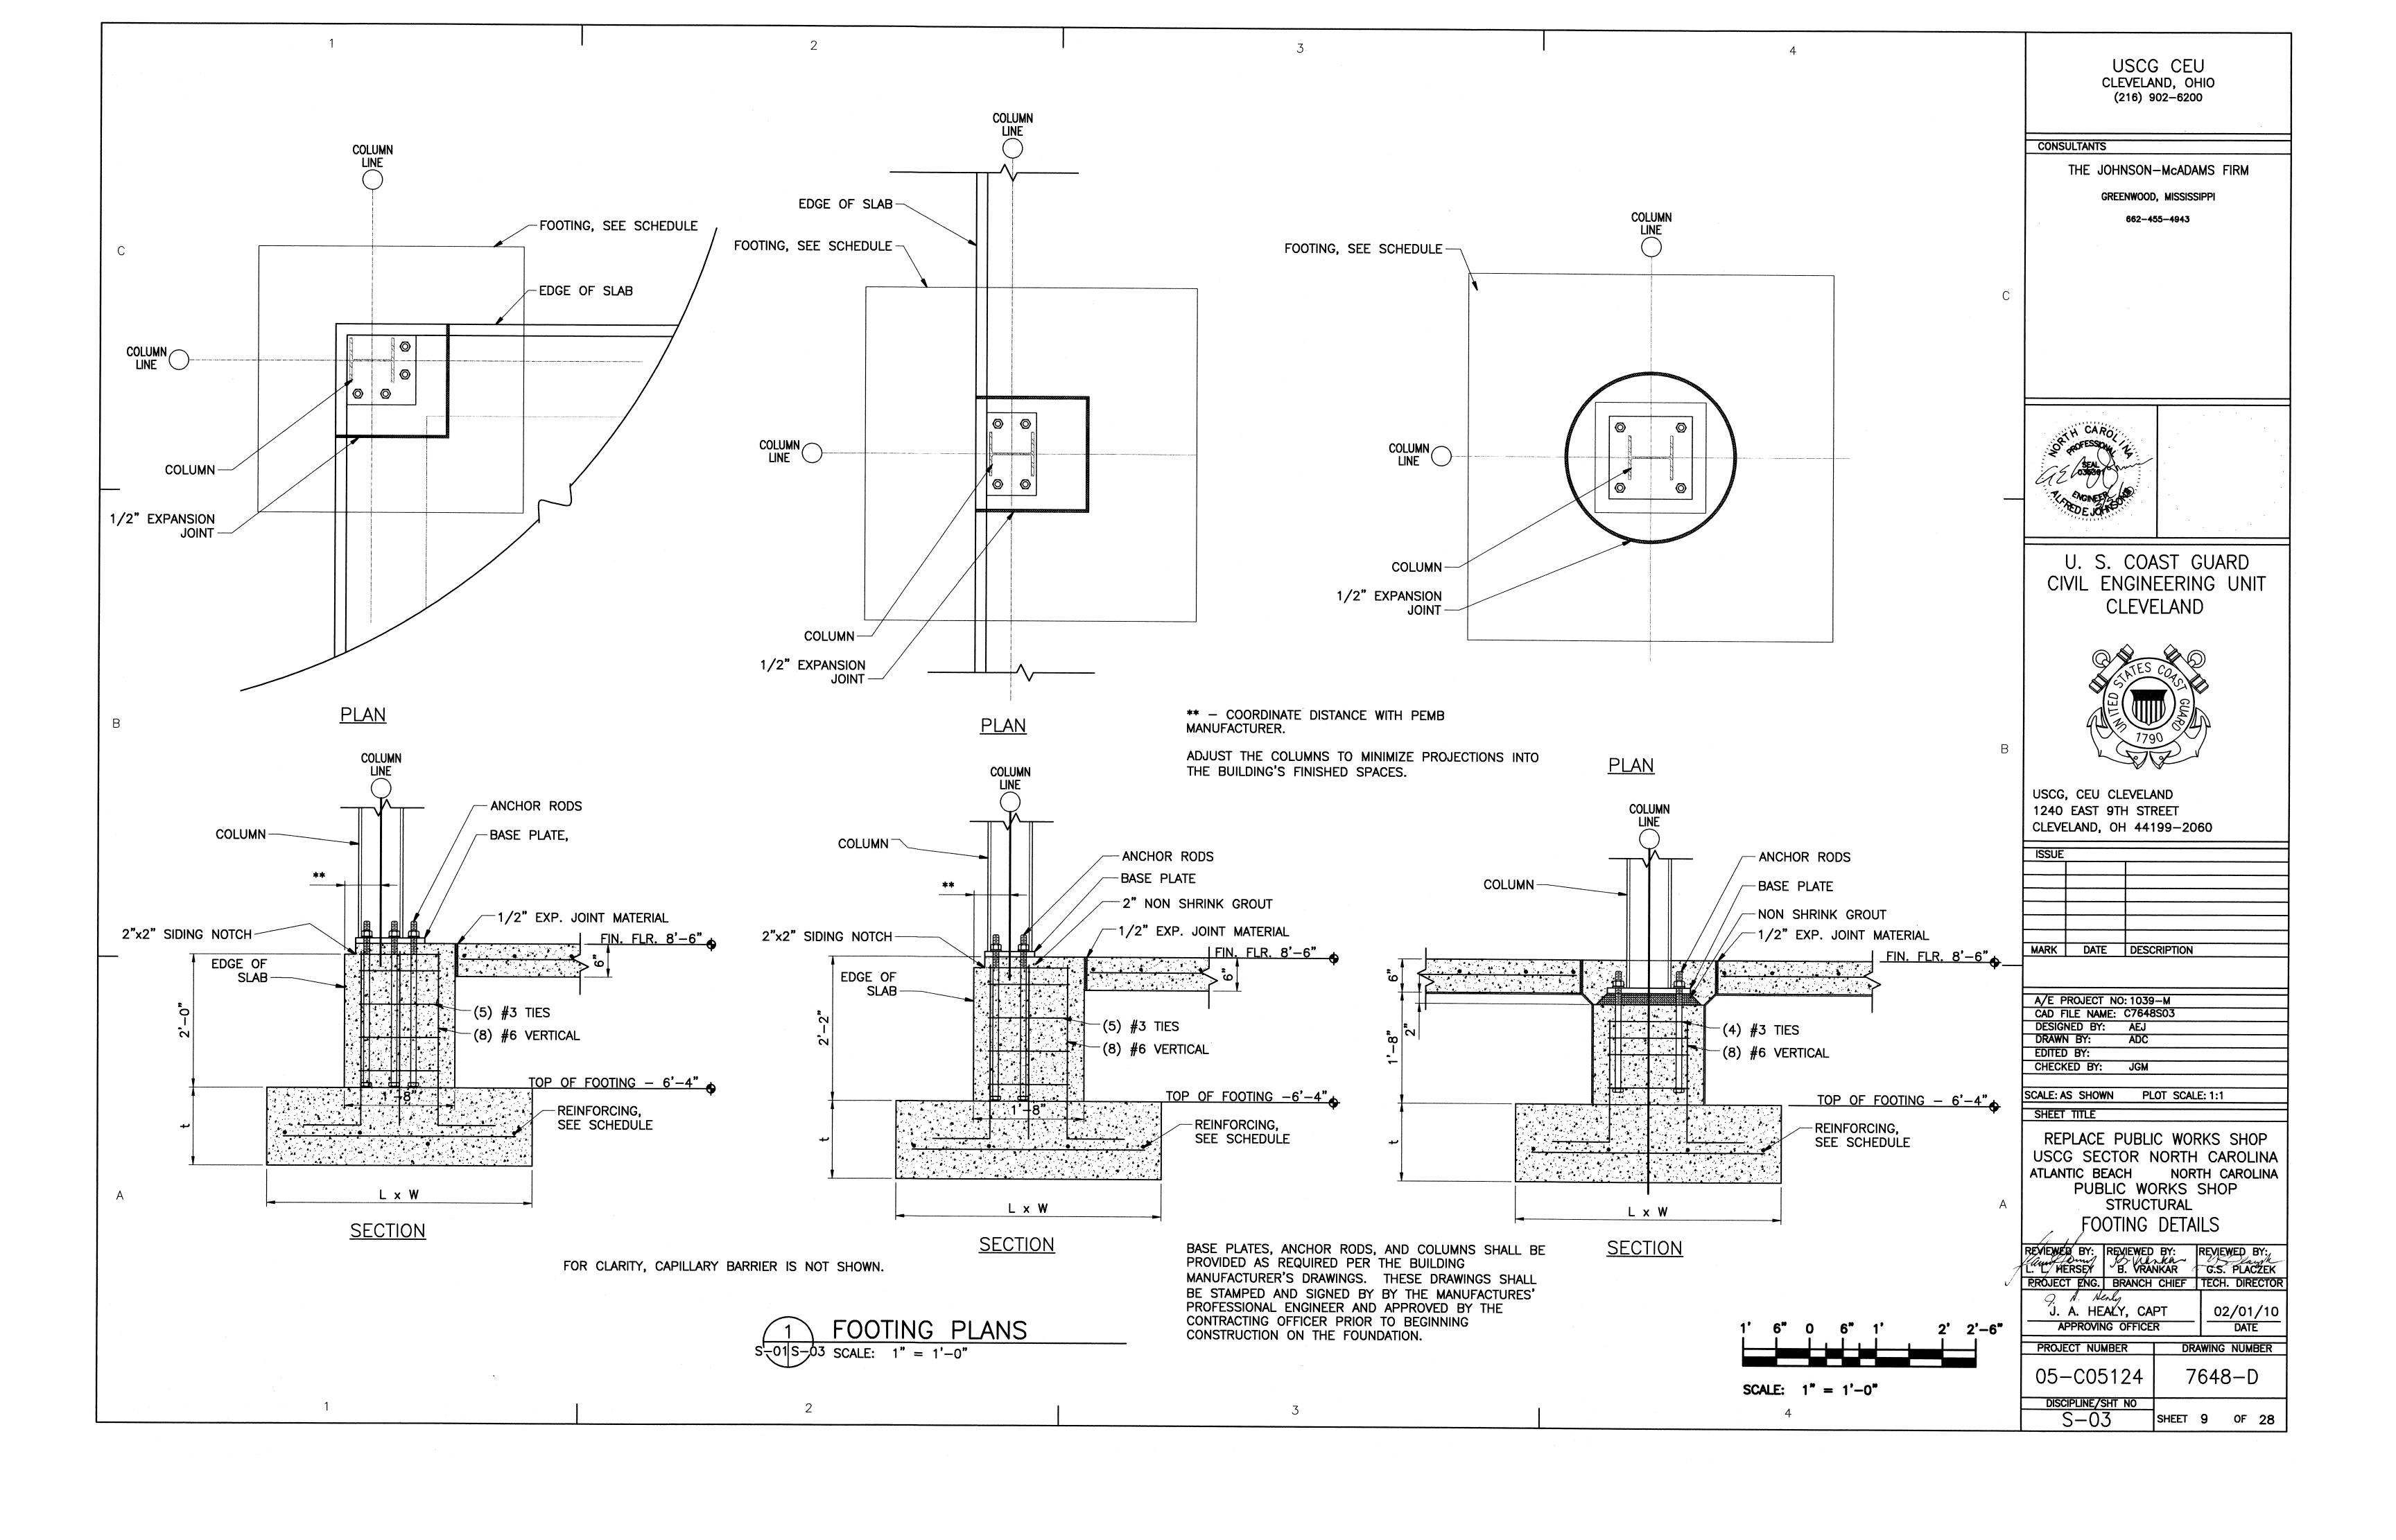

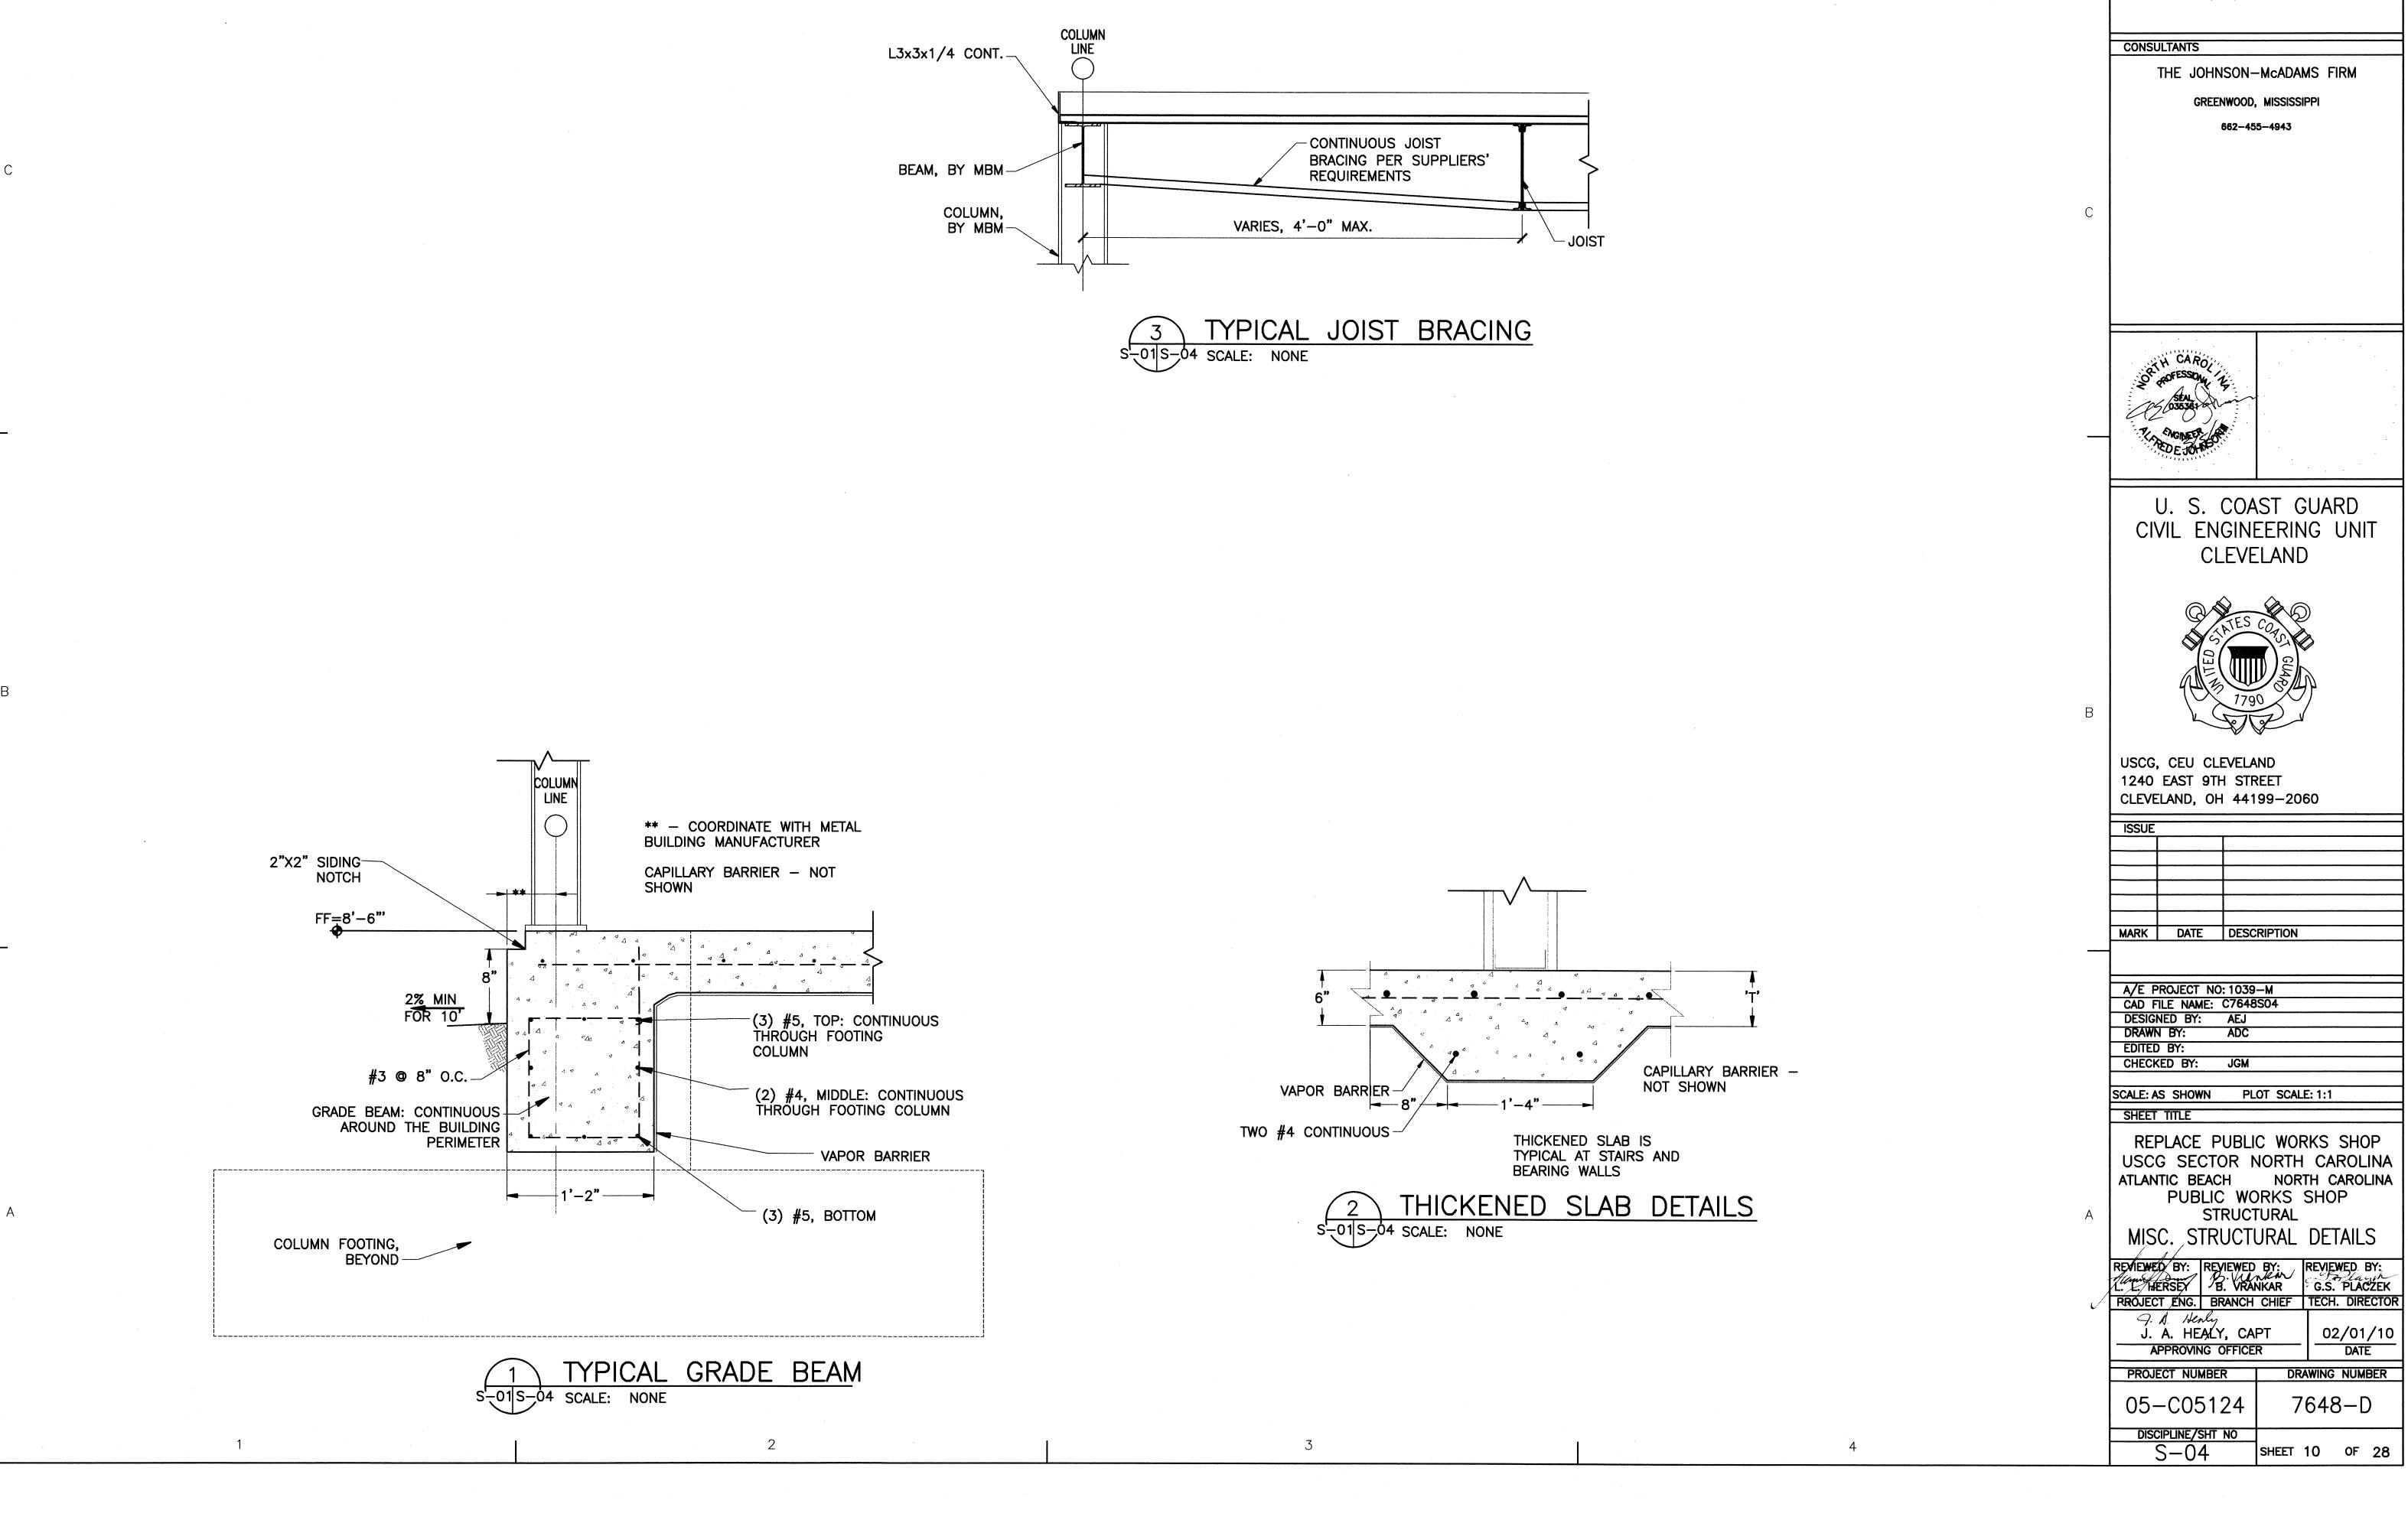


USCG CEU CLEVELAND, OHIO (216) 902-6200

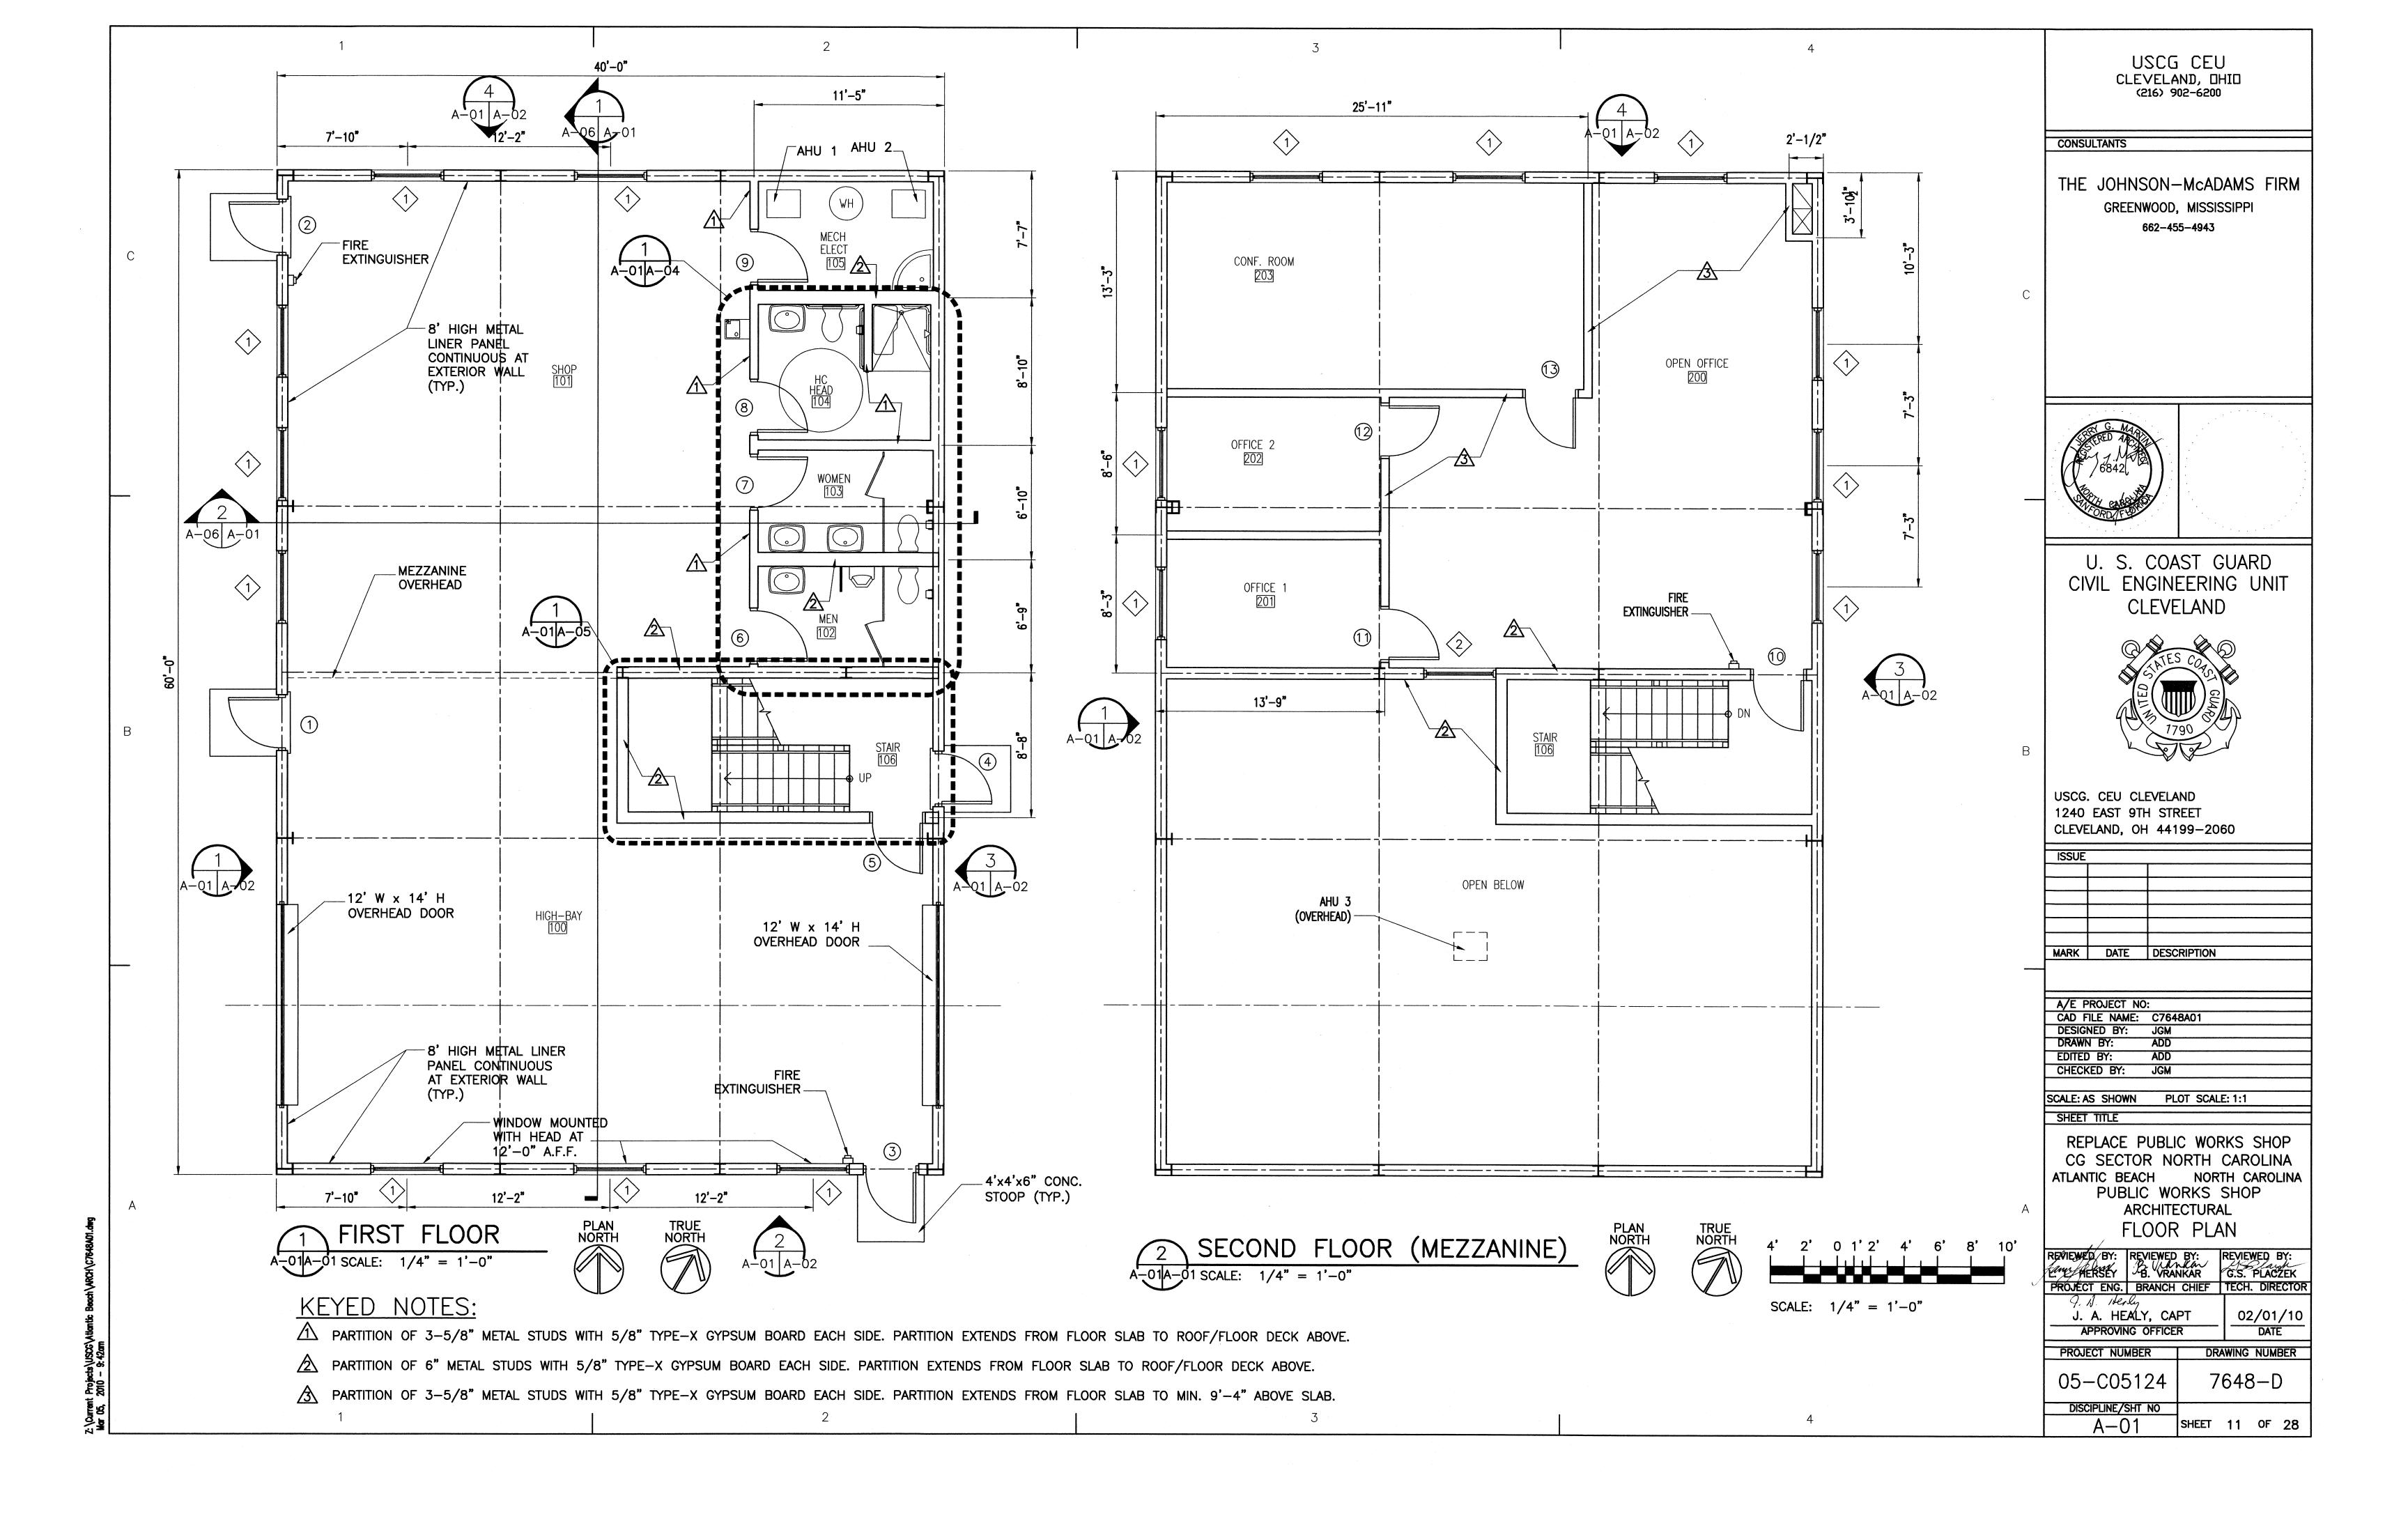


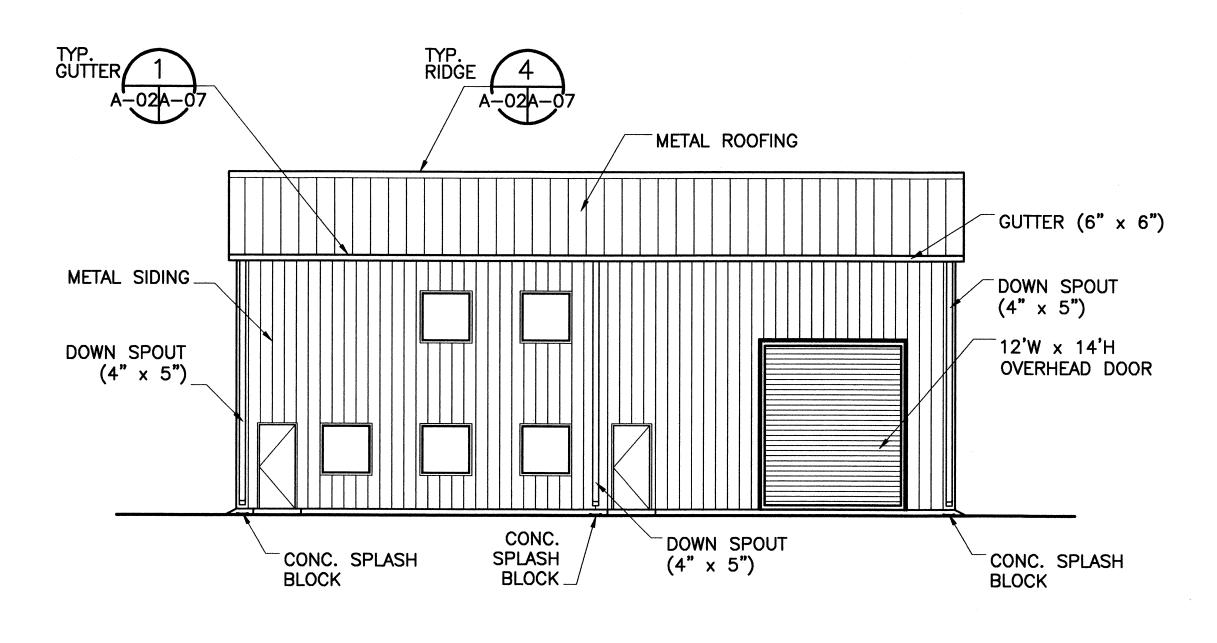


WEST ELEVATION
A-01A-02 SCALE: 1/8"=1'-0"

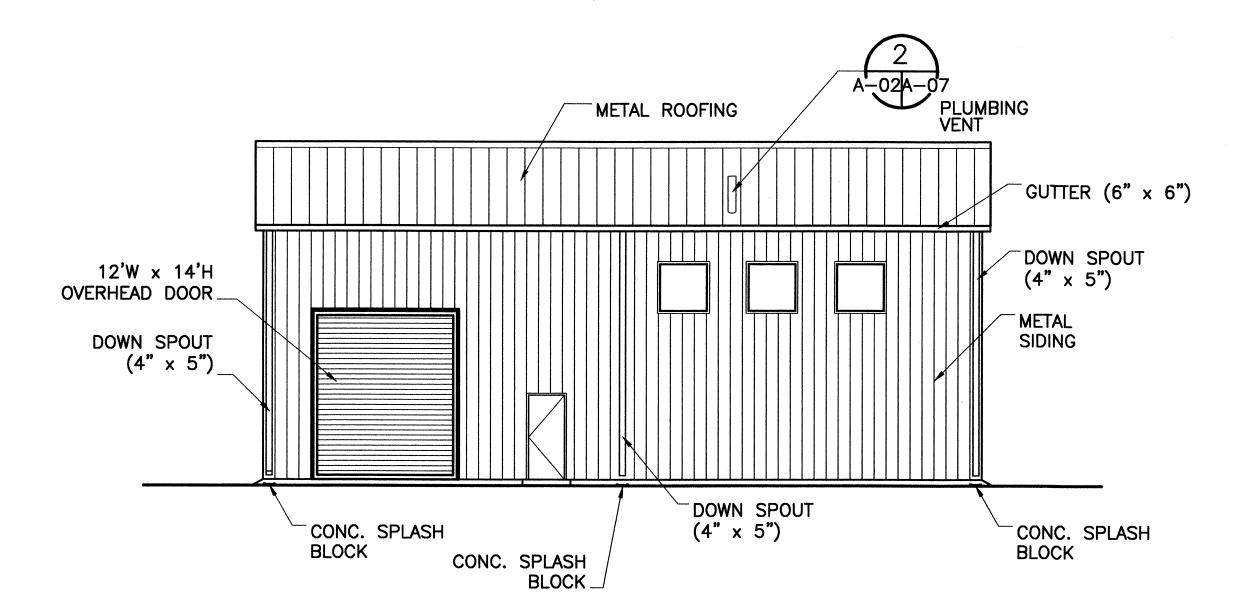




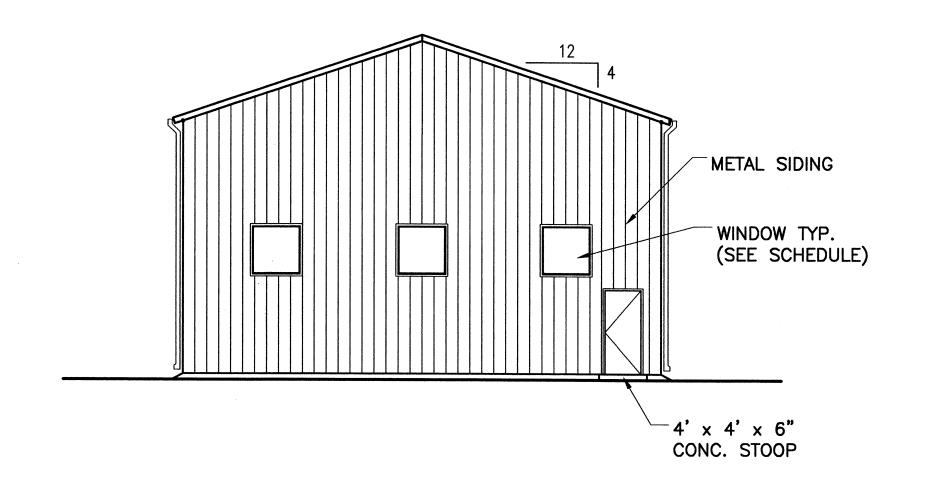

2 SOUTH ELEVATION 4-01A-02 SCALE: 1/8"=1'-0"

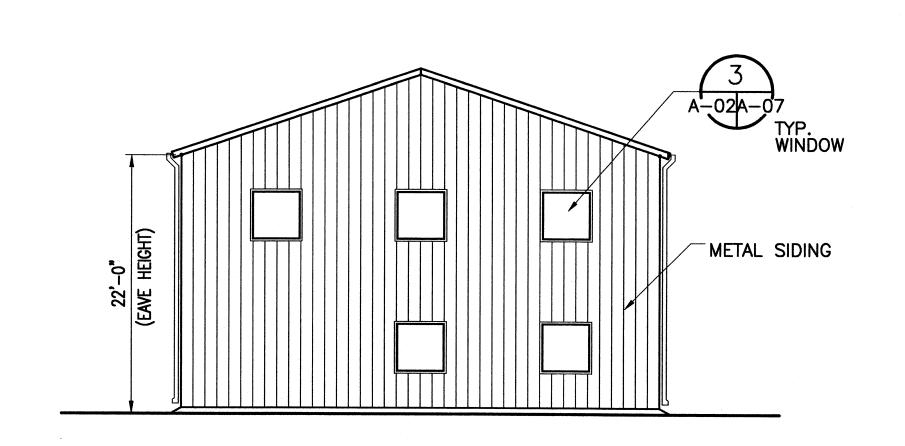


4 NORTH ELEVATION
A-01A-02 SCALE: 1/8"=1'-0"

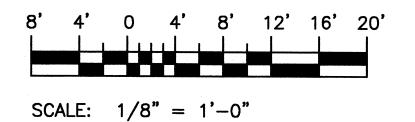

USCG CEU CLEVELAND, OHIO (216) 902-6200

CONSULTANTS

THE JOHNSON—McADAMS FIRM
GREENWOOD, MISSISSIPPI
662-455-4943

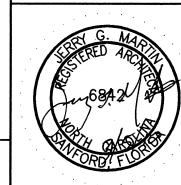

U. S. COAST GUARD CIVIL ENGINEERING UNIT CLEVELAND



USCG. CEU CLEVELAND 1240 EAST 9TH STREET CLEVELAND, OH 44199-2060

ISSUE	<u></u>						
MARK	DATE	DESCRIPTION					

A/E PROJECT NO	:
CAD FILE NAME:	C7648A02
DESIGNED BY:	JGM
DRAWN BY:	ADD
EDITED BY:	ADD
CHECKED BY:	JGM

SCALE: AS SHOWN PLOT SCALE: 1:1
SHEET TITLE

REPLACE PUBLIC WORKS SHOP
CG SECTOR NORTH CAROLINA
ATLANTIC BEACH NORTH CAROLINA
PUBLIC WORKS SHOP
ARCHITECTURAL
ELEVATIONS

REVIEWED BY:	REVIEWED	BY:	REVIEWED	BY:
L. L. HERSEY	REVIEWED B. VRAI	NKAR	G.S. PLA	ZEK
PROJECT ENG.	BRANCH	CHIEF	TECH. DIF	RECTOR
J. A. HE APPROVIN	02/0°			
PROJECT NUM	MBER	DR	AWING NUM	IBER
05-C05	5124	7	648-1	D

DISCIPLINE/SHT NO
A-02
SHEET 12 OF 28

Current Projects/USCC\Attentic Beach\ARCH\C7648

2

3

ROO	ROOM FINISH SCHEDULE										
RO	ROOM		BASE	SE WALLS			CE	ILING	NOTES		
NUMBER	NAME			NORTH	EAST	SOUTH	WEST				ROOM
100	HIGH-BAY	CONO	M D					MATL.	HEIGHT		NUMBER
101		CONC	MLP		MLP	MLP	MLP	P-EXPS	VARIES	1	100
	SHOP	CONC	MLP	MLP	MLP		MLP	P-EXPS	9'-6"		101
102	MEN'S HEAD	VCT	RB	P-GWB	P-GWB	P-GWB	P-GWB	ACT	9'-6"		102
103	WOMEN'S HEAD	VCT	RB	P-GWB	P-GWB	P-GWB	P-GWB	ACT	9'-6"		103
104	H.C. HEAD	VCT	RB	P-GWB	P-GWB	P-GWB	P-GWB	ACT	9'-6"		
105	MECH. ELECT.	CONC	RB	P-GWB	P-GWB	P-GWB	P-GWB	P-EXPS	9'-6"		104
106	STAIR	CONC	RB	P-GWB	P-GWB	P-GWB	P-GWB				105
200	OPEN OFFICE	CONC	RB	P-GWB	P-GWB	P-GWB	P-GWB	P-GWB	20'-4"		106
201	OFFICE 1	CONC	RB	P-GWB	P-GWB			ACT	9'-0"		200
202	OFFICE 2	CONC	RB	P-GWB		P-GWB	P-GWB	ACT	9'-0"		201
203	CONFERENCE RM	CONC	RB		P-GWB	P-GWB	P-GWB	ACT	9'-0"		202
	CO.T. LINEITOL INVI	CONC	ND ND	P-GWB	P-GWB	P-GWB	P-GWB	ACT	9'-0"		203
			-								

FINISH SCHEDULE LEGEND

ACT ACOUSTICAL CEILING TILE CMU CONCRETE MASONRY UNIT

CONC EXPOSED CONCRETE WITH SEALER EXPS EXPOSED STRUCTURE

GWB GYPSUM WALL BOARD P- PAINTED

RB RESILIENT BASE

VCT VINYL COMPOSITION TILE

MLP METAL LINER PANEL (8'-0" HIGH)

KEYED FINISH SCHEDULE NOTES

INSIDE FACE OF WALL PANELS SHALL BE COVERED WITH MIN. 2-INCH THICK FIBERGLASS INSULATION WITH WHITE VINYL FACE TOWARD INSIDE OF ROOM.

GENERAL NOTES

- A. ALL EXPOSED STEEL STRUCTURE SHALL BE PAINTED.
- B. PROVIDE MIN. R-11 FIBERGLASS INSULATION IN EXTERIOR WALLS OF CONDITIONED SPACES.


DOOR SCHEDULE


NUMBER		DO	OR		HARDWARE	FR	FRAME	
	MARK	MATERIAL	THICKNESS	FINISH	SET	TYPE	FINISH	
1	Α	METAL	1 3/4"	PAINT	HW-1	METAL	PAINT	1
2	Α	METAL	1 3/4"	PAINT	HW-1	METAL	PAINT	1
3	<u> </u>	METAL	1 3/4"	PAINT	HW-1	METAL	PAINT	1
4	C	METAL	1 3/4"	PAINT	HW-1	METAL	PAINT	1, 2
5	C	METAL	1 3/4"	PAINT	HW-2	METAL	PAINT	2
6	C	METAL	1 3/4"	PAINT	HW-4	METAL	PAINT	
7	C	METAL	1 3/4"	PAINT	HW-4	METAL	PAINT	
8	C	METAL	1 3/4"	PAINT	HW-5	METAL	PAINT	
9	C	METAL	1 3/4"	PAINT	HW-3	METAL	PAINT	
10	С	METAL	1 3/4"	PAINT	HW-2	METAL	PAINT	1, 2
11	В	METAL	1 3/4"	PAINT	HW-3	METAL	PAINT	., _
12	В	METAL	1 3/4"	PAINT	HW-3	METAL	PAINT	
13	В	METAL	1 3/4"	PAINT	HW-3	METAL	PAINT	

KEYED DOOR SCHEDULE NOTES

1. EXIT DOOR

2. 45 MINUTE FIRE RATED ASSEMBLY

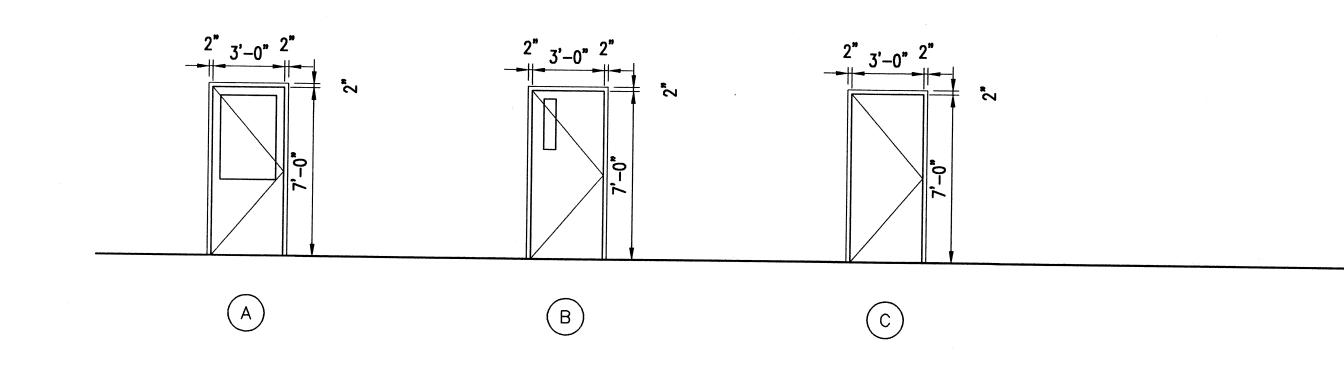

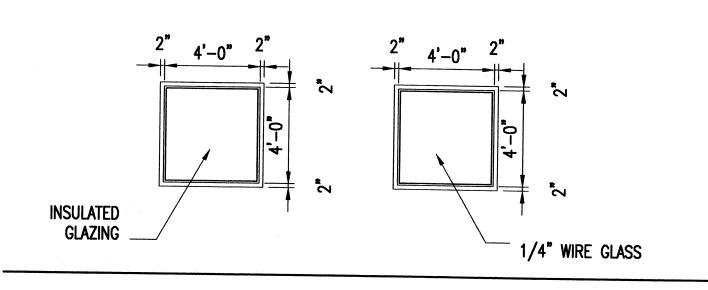

NOTE:

ALL WINDOWS MOUNTED WITH HEAD AT 7'-0" A.F.F. EXCEPT FOR WINDOWS ON SOUTH WALL OF HIGH BAY 100 (HEAD AT 12'-0" A.F.F.)

USCG CEU CLEVELAND, DHID (216) 902-6200

CONSULTANTS

THE JOHNSON-McADAMS FIRM GREENWOOD, MISSISSIPPI 662-455-4943

U. S. COAST GUARD CIVIL ENGINEERING UNIT CLEVELAND



USCG. CEU CLEVELAND 1240 EAST 9TH STREET CLEVELAND, OH 44199-2060

ISSUE	-	
MARK	DATE	DESCRIPTION

A/E PROJECT NO	•	
CAD FILE NAME:	C7648A03	
DESIGNED BY:	JGM	
DRAWN BY:	ADD	
DITED BY:	ADD	
CHECKED BY:	JGM	

SCALE: AS SHOWN PLOT SCALE: 1:1

REPLACE PUBLIC WORKS SHOP CG SECTOR NORTH CAROLINA ATLANTIC BEACH NORTH CAROLINA PUBLIC WORKS SHOP ARCHITECTURAL SCHEDULES


	6 16			-		
	REVIEWED BY:	REVIEWED	V 4 . /	REVIE	WED	BY:
//	L. MY HERSEY		NKAR '	G.S.	PLAC	ZEK
/	PROJECT ENG.	BRANCH	CHIEF	TECH	. DIR	ECTOR
	9. D. Ben					
	ار کا ایکور J. A. HE			02	2/01	/10
	APPROVIN	IG OFFICE	IR DATE			
	PROJECT NUM	DRAWING NUMBER				
	05-C05	7648-D				
	DISCIPLINE/S	SHT NO				
	A-0	3	SHEET	13	OF	28

ISSUE					
ISSUE					


AIVIV	DATE	DESCRIPTION	
A/E D	DO IFOT NO	2.	
	ROJECT NO		
		C7648A03	
DESIGN	NED BY:	JGM	
DRAWN	RY.	ADD	

SHEET TITLE



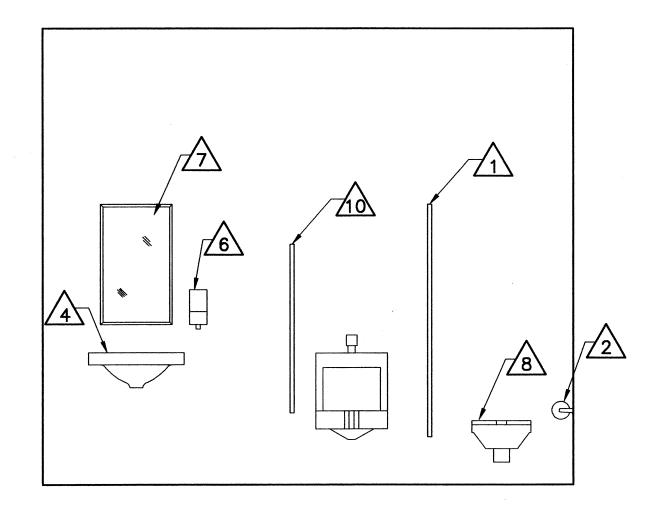



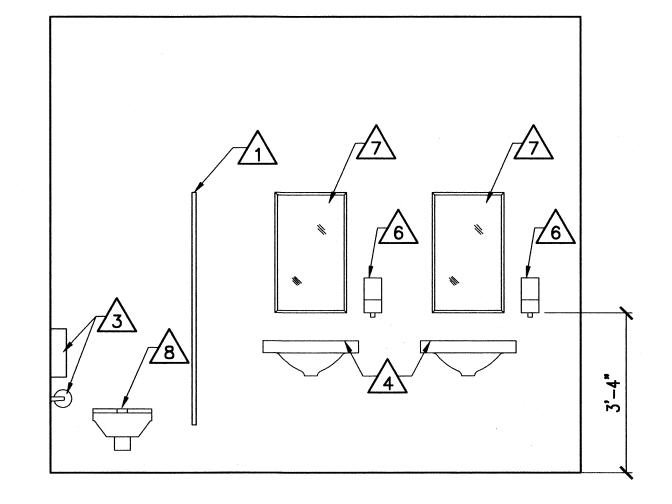





KEYED NOTES:

- A PROVIDE TOILET PARTITION.
- PROVIDE TOILET TISSUE DISPENSER. MOUNT WITH CENTERLINE AT 19" A.F.F. AND 34" FROM BACK WALL.
- PROVIDE SANITARY NAPKIN WASTE DISPOSAL UNIT. MOUNT WITH CENTERLINE AT 19" A.F.F. AND 24" FROM BACK WALL. PROVIDE TOILET TISSUE DISPENSER. MOUNT WITH CENTERLINE AT 30" A.F.F. AND 24" FROM BACK WALL.
- PROVIDE LAVATORY AS SPECIFIED. MOUNT WALL HUNG LAVATORY AT 2'-9" A.F.F. AND INSULATE SUPPLY AND DRAIN PIPING.
- PROVIDE SEMI-RECESSED COMBINATION PAPER TOWEL DISPENSER AND WASTE RECEPTACLE. MOUNT WITH CENTERLINE OF UNIT AT 48" A.F.F.
- PROVIDE SOAP DISPENSER AT EACH LAVATORY (TYP.). MOUNT AT 3'-4" A.F.F.
- PROVIDE 18" BY 30" SURFACE MOUNTED MIRROR AT EACH LAVATORY (TYP.).

 MOUNT REFLECTIVE SURFACE OF MIRROR AT 3'-4" A.F.F.
- PROVIDE WATER CLOSET.
- 8" FLOOR TO CEILING PARTITION.
- WALL MOUNTED URINAL SCREEN.
- PROVIDE GYPSUM BOARD FURRING AT COLUMN.

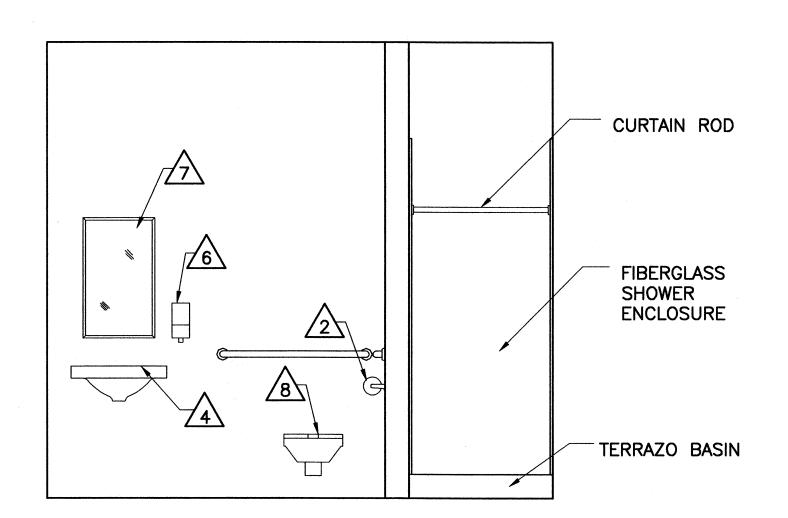




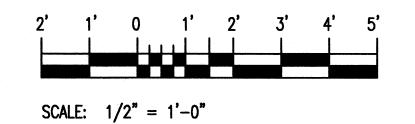

USCG CEU CLEVELAND, DHID (216) 902-6200

CONSULTANTS

THE JOHNSON—McADAMS FIRM GREENWOOD, MISSISSIPPI 662-455-4943

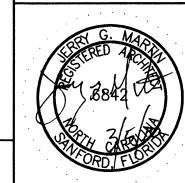

U. S. COAST GUARD CIVIL ENGINEERING UNIT CLEVELAND



USCG. CEU CLEVELAND 1240 EAST 9TH STREET CLEVELAND, OH 44199-2060

ISSUE		
MARK	DATE	DESCRIPTION

A/E PROJECT NO:

CAD FILE NAME: C7648A04

DESIGNED BY: JGM

DRAWN BY: ADD

EDITED BY: ADD

CHECKED BY: JGM

SCALE: AS SHOWN PLOT SCALE: 1:1
SHEET TITLE

REPLACE PUBLIC WORKS SHOP
CG SECTOR NORTH CAROLINA
ATLANTIC BEACH NORTH CAROLINA
PUBLIC WORKS SHOP
ARCHITECTURAL

ENLARGED PLAN/ELEVATIONS

REVIEWED BY:	REVIEWED	BY:	REVIEWED BY;	
L. HERSEY	B. VRAI	NKAR	G.S. PLACZEK	
PROJECT ENG.	BRANCH CHIEF		TECH. DIRECTOR	
J. A. HE	J. A. HEALY, CAPT APPROVING OFFICER			
PROJECT NUI	MBER	DRAWING NUMBER		
05-C05	5124	7648-D		
DISCIPLINE/S	SHT NO			

SHEET 14 OF 28

A-04