


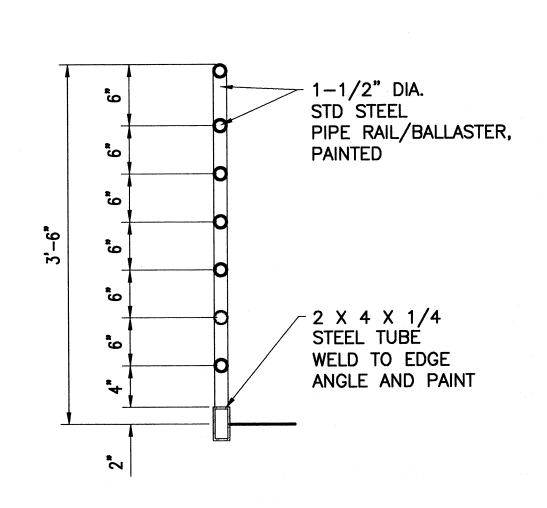


NOTE: ALL METAL COMPONENTS SHALL BE PAINTED.








SCALE: 1/2" = 1'-0"

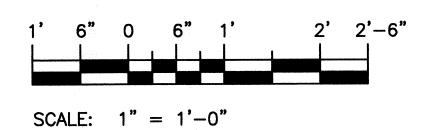

USCG CEU CLEVELAND, DHID (216) 902-6200

CONSULTANTS

THE JOHNSON-McADAMS FIRM GREENWOOD, MISSISSIPPI 662-455-4943

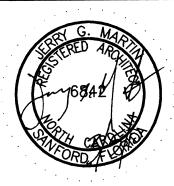

U. S. COAST GUARD CIVIL ENGINEERING UNIT CLEVELAND



USCG. CEU CLEVELAND 1240 EAST 9TH STREET CLEVELAND, OH 44199-2060


ISSUE		
MARK	DATE	DESCRIPTION


A/E PROJECT NO CAD FILE NAME:	
•	
DESIGNED BY:	JGM
DRAWN BY:	ADD
EDITED BY:	ADD
CHECKED BY:	JGM

SCALE: AS SHOWN PLOT SCALE: 1:1 SHEET TITLE

REPLACE PUBLIC WORKS SHOP CG SECTOR NORTH CAROLINA ATLANTIC BEACH NORTH CAROLINA
PUBLIC WORKS SHOP ARCHITECTURAL ENLARGED STAIRS

	//	J 11 (OL		/ \III \					
	REVIEWED BY:	REVIEWED	BY:	REVIE					
. 1	L. L. HERSEY	B. VRAI	NKAR '		PLACZEK				
	PROJECT ENG.	BRANCH	CHIEF	TECH	. DIRECTOR				
	), A. He J. <b>A.</b> HE	aly CA	PT	02	2/01/10				
		IG OFFICE							
	AFFROVII	- OTTICL	· · · · · · · · · · · · · · · · · · ·		DAIL				
	PROJECT NUI	MBER	DRAWING NUMBER						
	05-C05		7648-D						
	DISCIPLINE/S	SHT NO							
	A-C	)5	SHEET	15	OF 28				

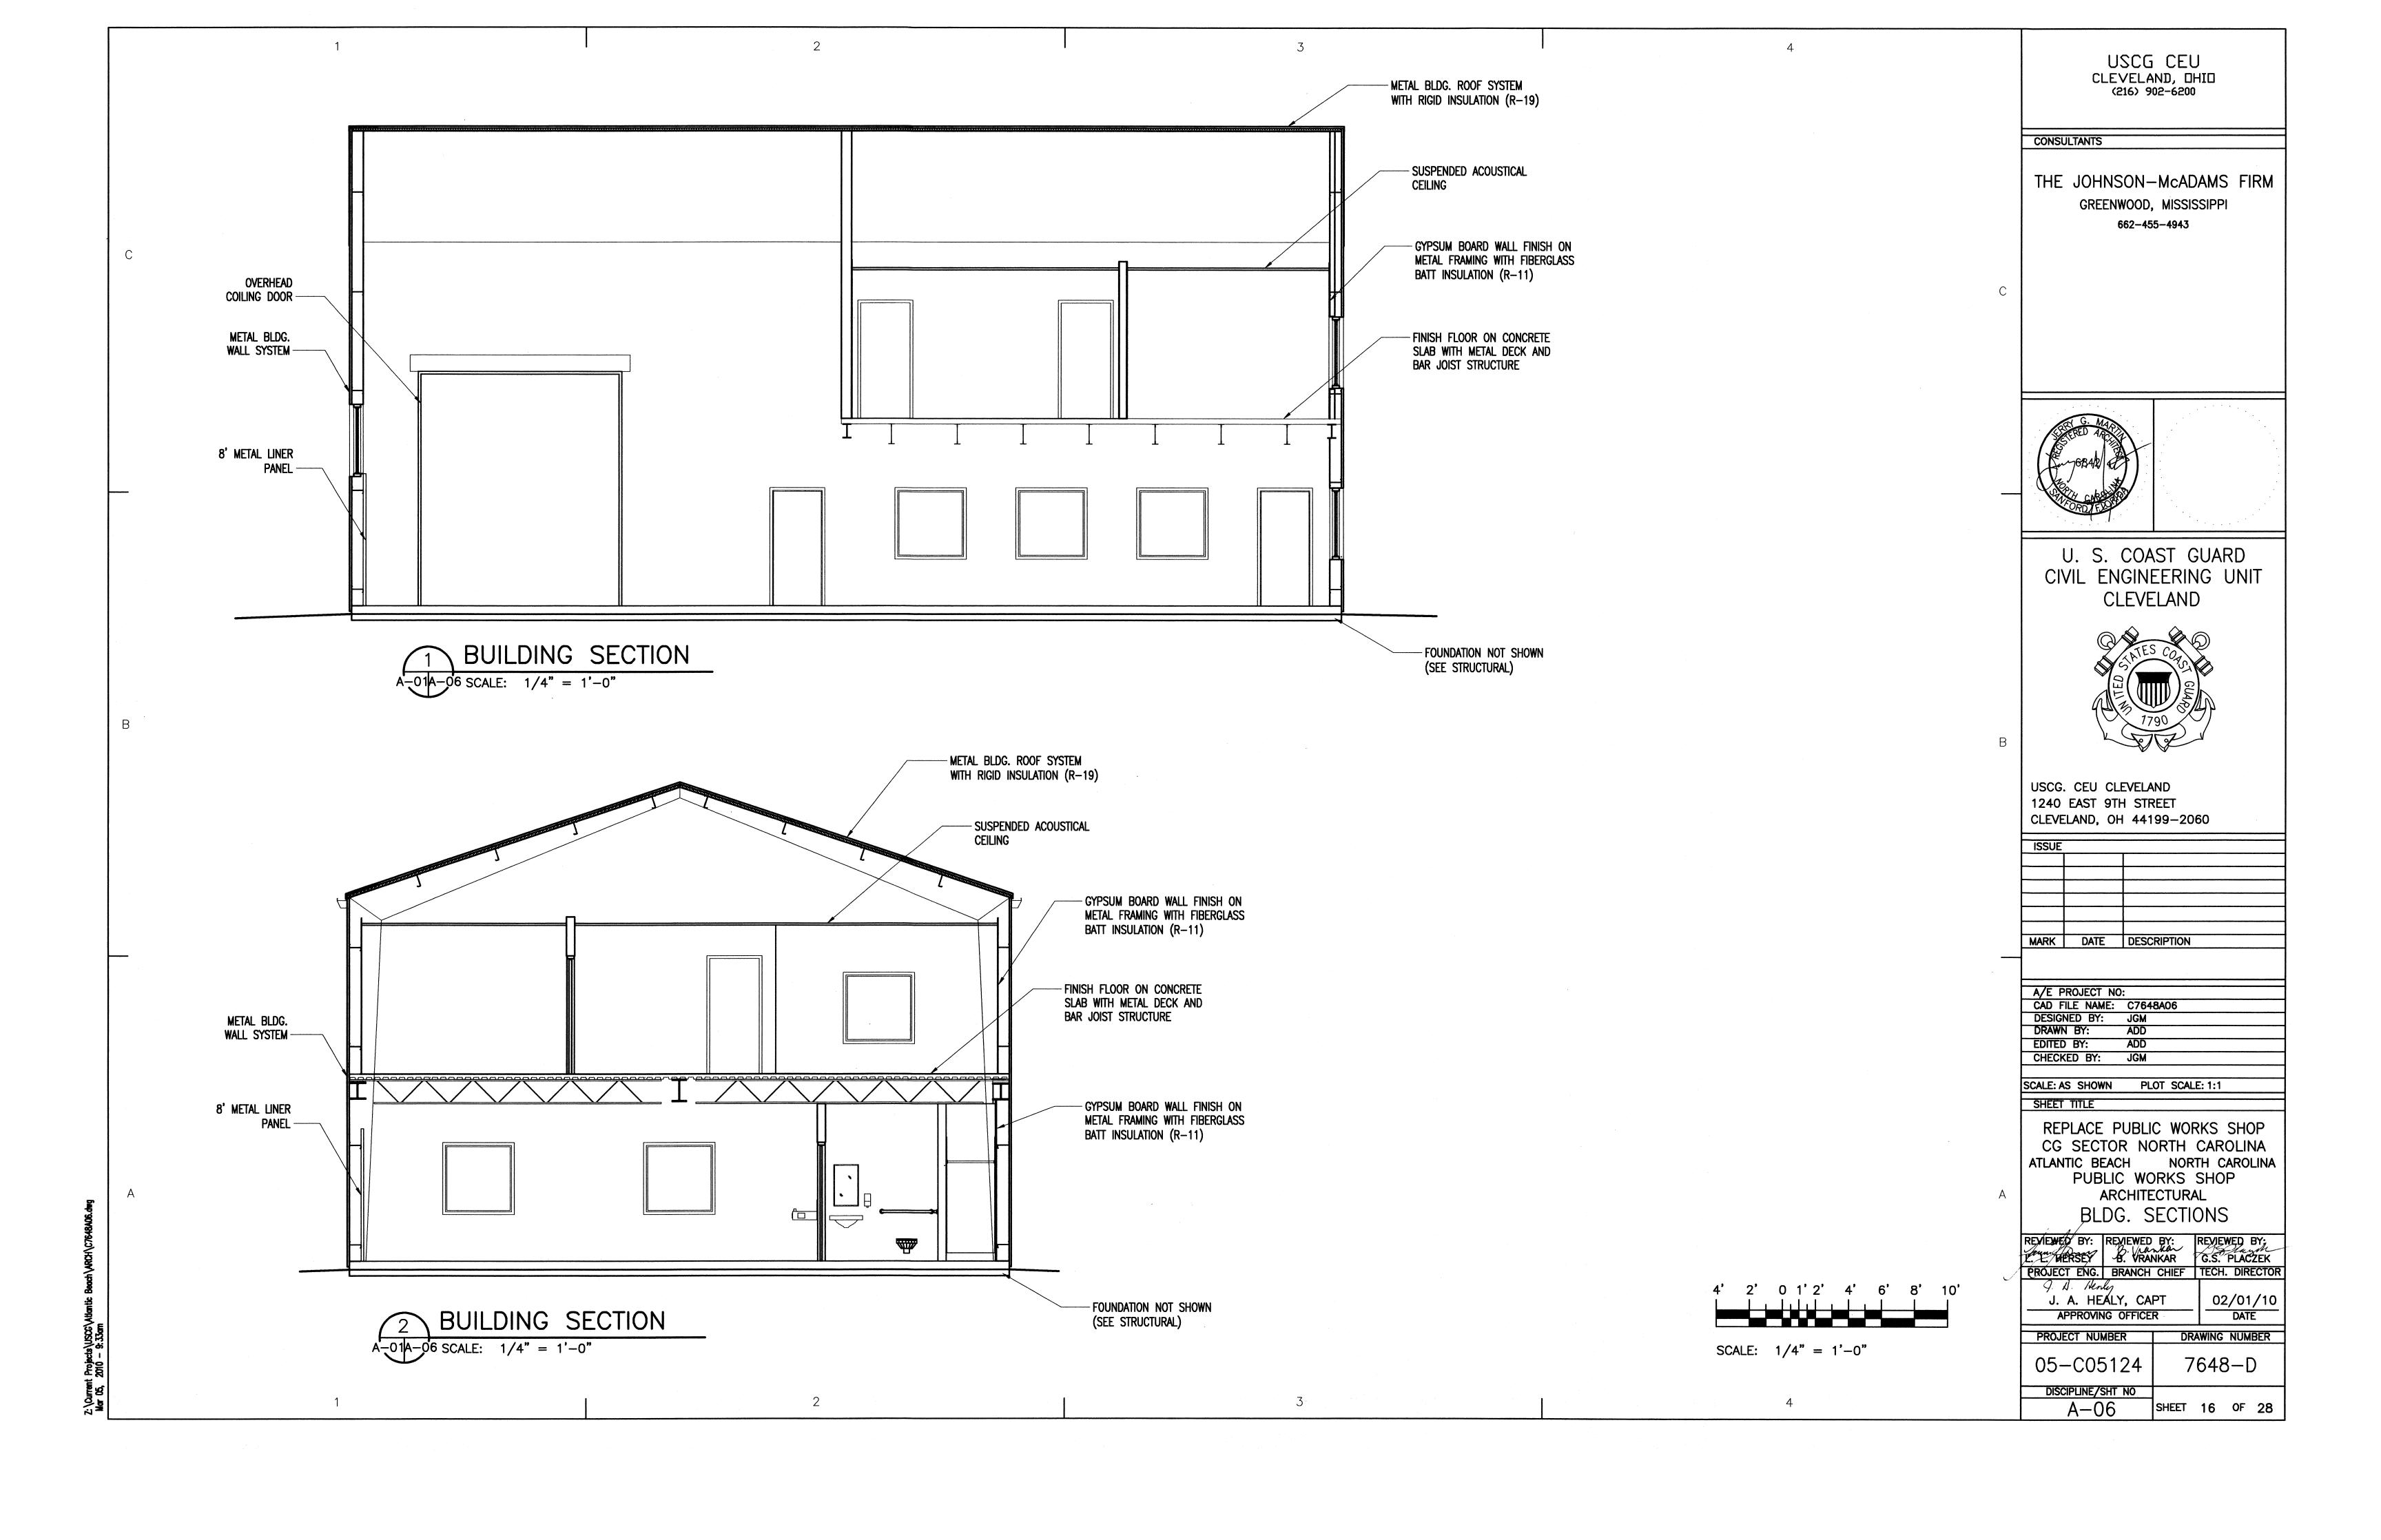


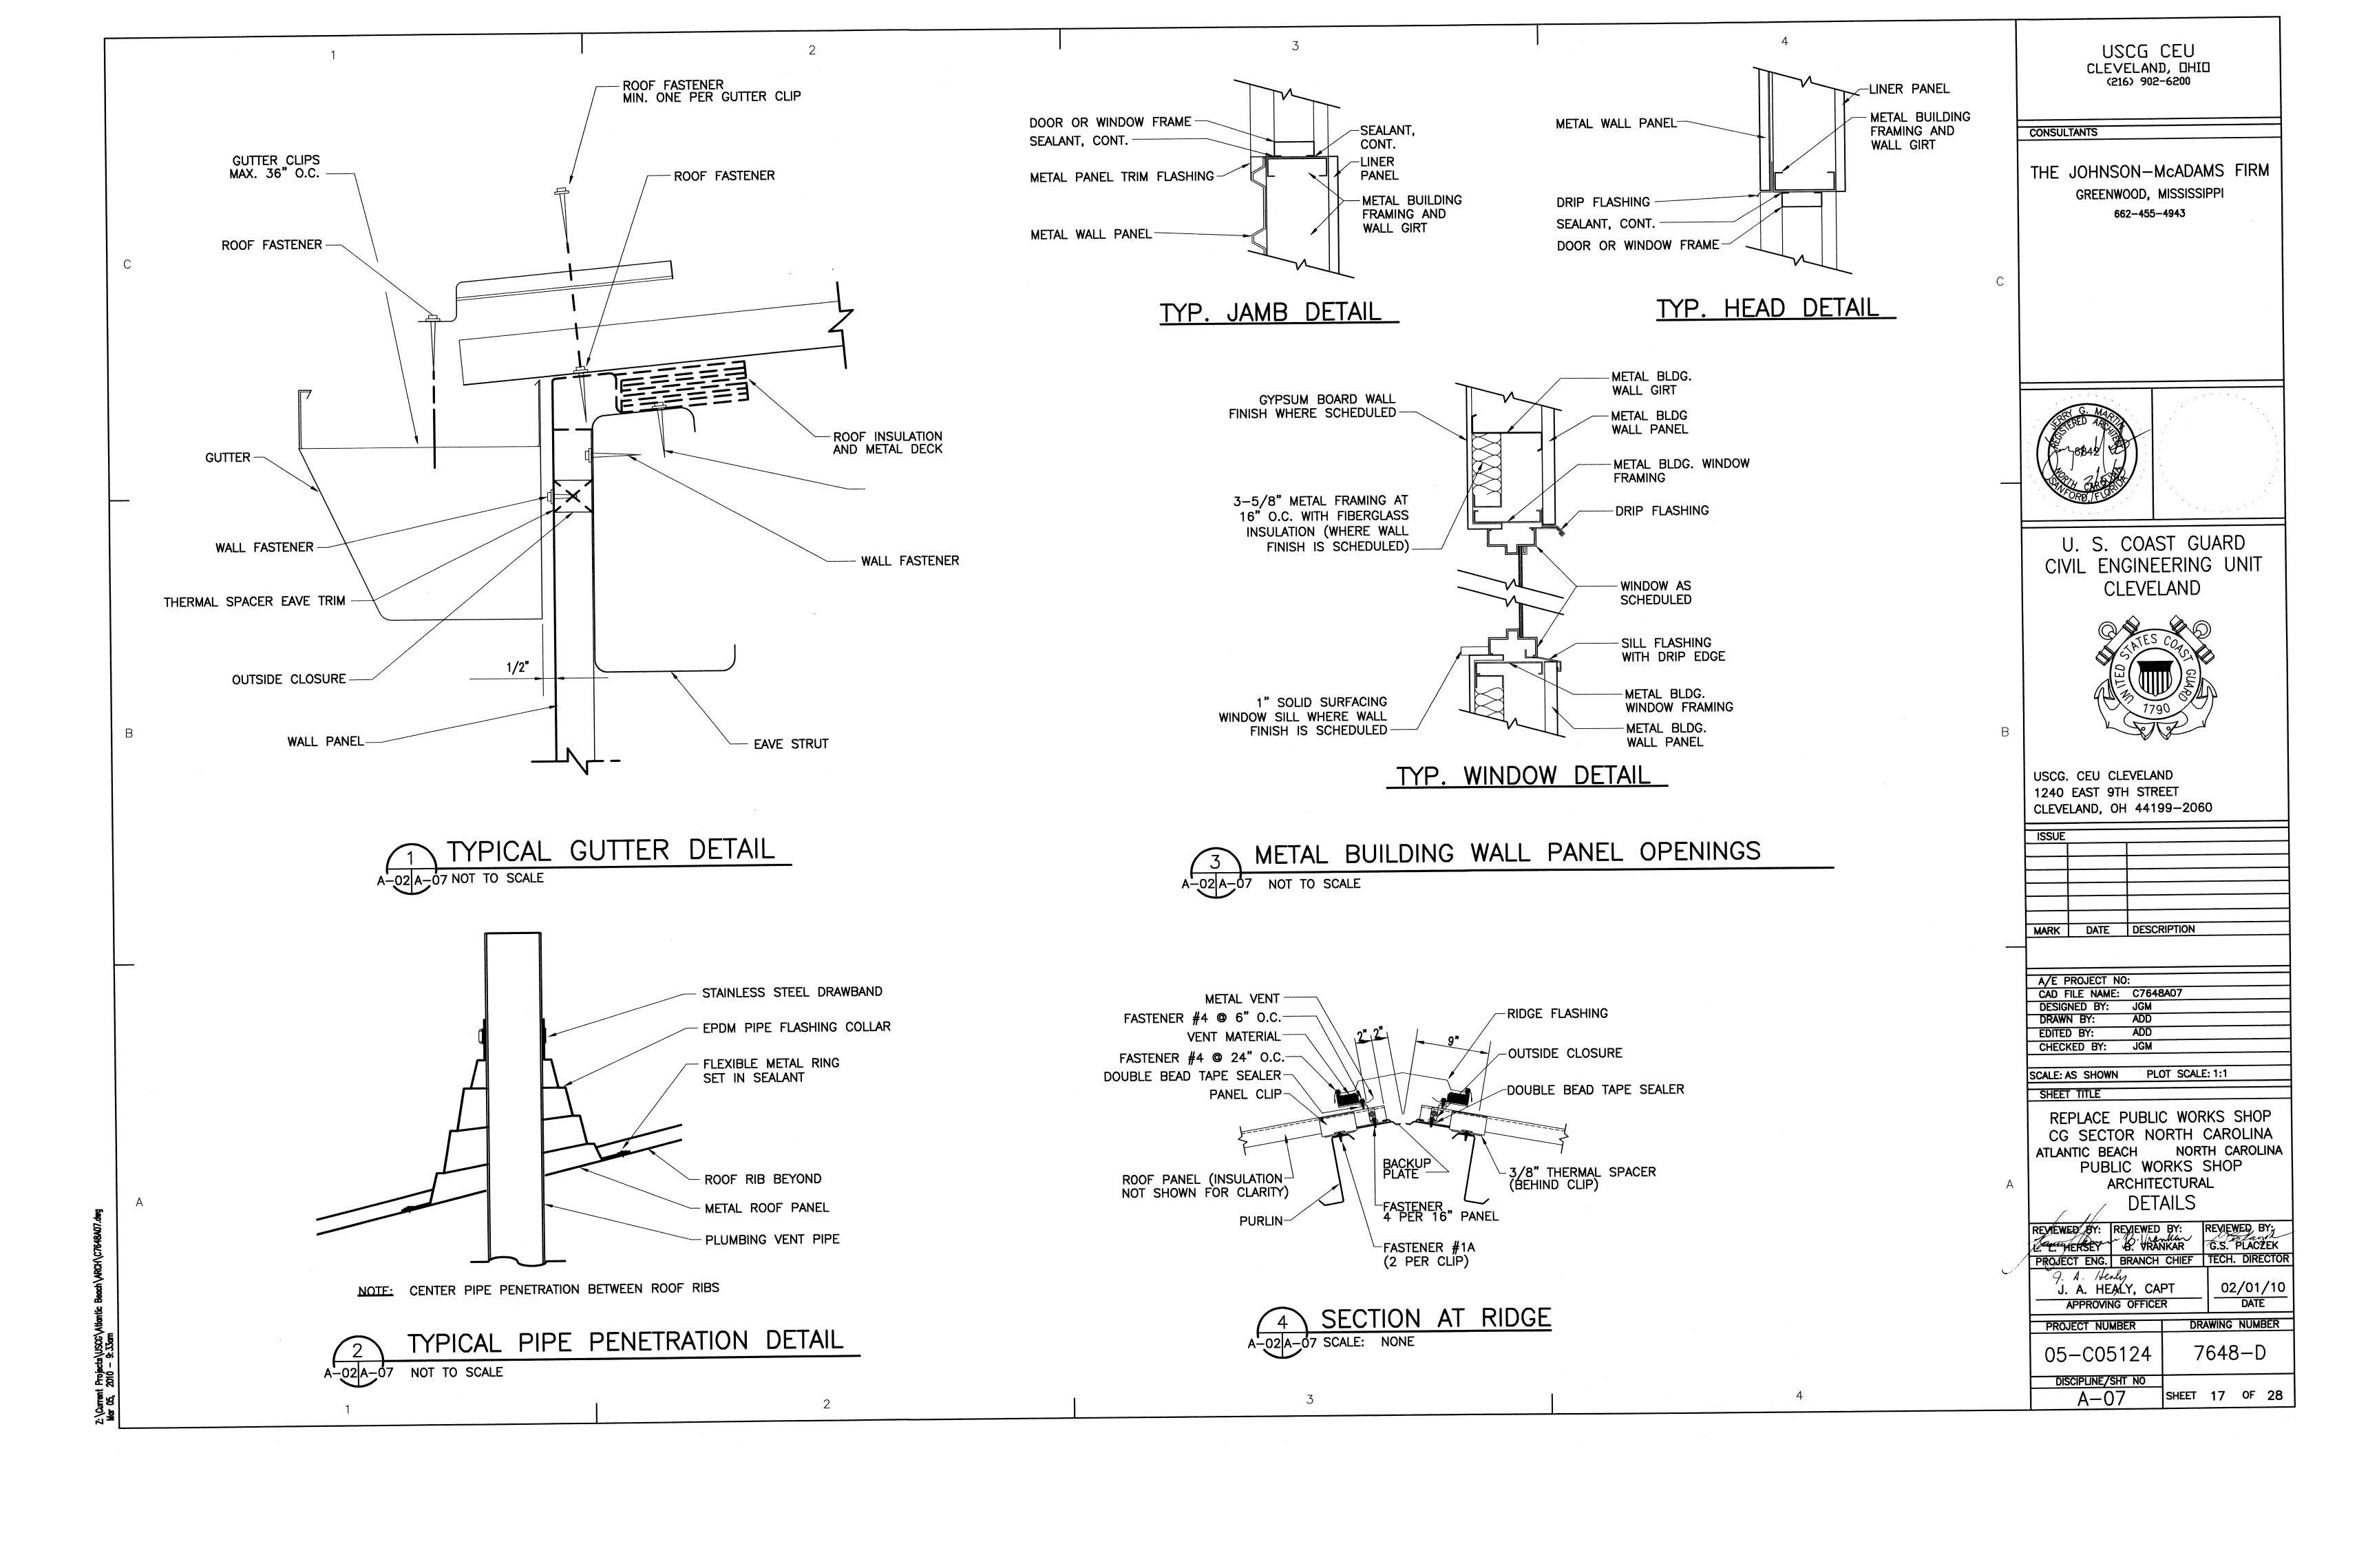


KEYED NOTES


1 PROVIDE CEILING EXHAUST FAN PER FAN SCHEDULE. ROUTE 4"ø EXHAUST DUCT TO WALL. PROVIDE RAIN CAP.

2 PROVIDE 8" THICK CONCRETE PAD FOR HEAT PUMPS. 3,000 PSI CONCRETE WITH 6" SKIRT ON ALL

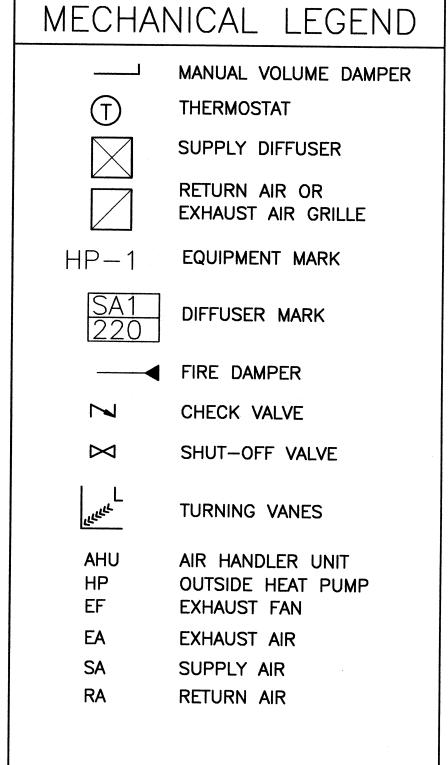

- A. ALL WORK SHALL CONFORM TO THE LATEST EDITION OF MECHANICAL, GAS, PLUMBING, AND ELECTRICAL CODES FOR THE AUTHORITIES HAVING JURISDICTION. ALL LISTED AND NON-LISTED APPLIANCES ARE TO BE INSTALLED PER IMC 304.1 AND IFGC 306.5. EVERY APPLIANCE SHALL BE LOCATED WITH RESPECT TO BUILDING CONSTRUCTION AND OTHER EQUIPMENT SO AS TO PERMIT ACCESS AND SERVICE PER IMC SECTION 303. EQUIPMENT SHALL BE INSTALLED PER MANUFACTURER'S INSTRUCTIONS.
- B. ENGINEERING DRAWINGS ARE DIAGRAMMATIC, AND WHILE THE ENGINEER HAS MADE A CONCERTED EFFORT TO ARRANGE AND LAYOUT EQUIPMENT AND PIPING IN A NON CONFLICTIVE MANNER, THE FINAL RESPONSIBILITY OF
- C. CONTRACTOR SHALL NOT FABRICATE ANY PIPING, DUCTWORK NOR INSTALL ANY EQUIPMENT PRIOR TO VERIFICATION OF CLEARANCES, REVIEWING ARCHITECTURAL, STRUCTURAL, PLUMBING, DRAWINGS. CONTRACTOR SHALL INSPECT EXISTING CONDITIONS TO VERIFY THAT NO FIELD CHANGES HAVE OCCURRED THAT MAY EFFECT WORK. CONTRACTOR TO FIELD VERIFY ALL
- E. CONTRACTOR SHALL BE ALLOWED TO RECONFIGURE ASPECT RATIO OF DUCTWORK TO AVOID CONFLICTS. MAINTAIN ORIGINAL CROSS SECTIONAL AREA AND PROVIDE GRADUAL TRANSITIONS.
- F. DIMENSIONS FOR DUCTWORK LISTED ON DRAWINGS ARE FOR CLEAR DIMENSIONS. APPLY A 1" EXTERNAL INSULATION TO ALL DUCTWORK. DUCTWORK TO BE GALVANIZED STEEL. FLEX DUCT CAN BE ONLY USED 6 FEET WITHIN DIFFUSER.
- DETECTORS, THEN THE PACKAGED UNITS SHALL SHUT DOWN.

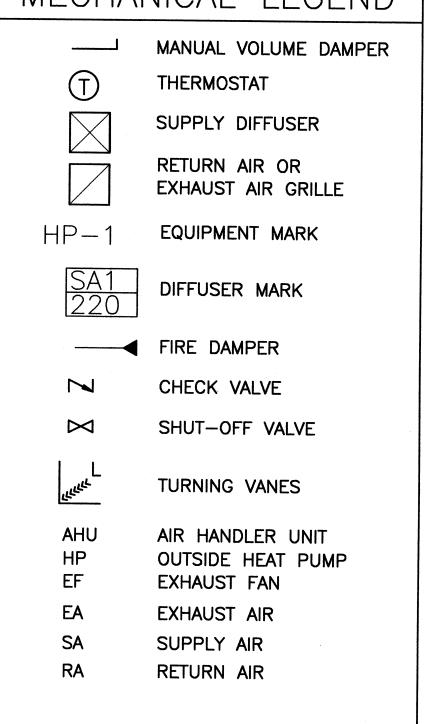

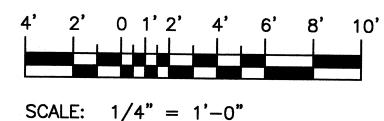

USCG CEU CLEVELAND, OHIO

CONSULTANTS

THE JOHNSON-McADAMS FIRM GREENWOOD, MISSISSIPPI 662-455-4943

(216) 902-6200



U. S. COAST GUARD CIVIL ENGINEERING UNIT **CLEVELAND** 



USCG. CEU CLEVELAND 1240 EAST 9TH STREET CLEVELAND, OH 44199-2060

ISSUE		
		-
MARK	DATE	DESCRIPTION

A/E PROJECT NO	):	
CAD FILE NAME:	C7648M01	-
DESIGNED BY:	TSM	
DRAWN BY:	TSM	_
EDITED BY:	TSM	
CHECKED BY:	JGM	
		-

SCALE: AS SHOWN PLOT SCALE: 1:1 SHEET TITLE

REPLACE PUBLIC WORKS SHOP CG SECTOR NORTH CAROLINA ATLANTIC BEACH NORTH CAROLINA PUBLIC WORKS SHOP MECHANICAL

FLOOR PLAN MECHANICAL

REVIEWED BY:	REVIEWED		71	WED	
L. C. HERSEY	B. VRA	NKAR	G.S.	PLAC	ZEK
PROJECT ENG.	BRANCH	CHIEF	TECH	I. DIR	<b>ECTOR</b>
J. A. HE	ALY, CA NG OFFICE		02	2/01 DAT	
PROJECT NUI	MBER	DR.	AWING	NUM	BER
05-C05	,,	7	648	3-[	)
DISCIPLINE/S	SHT NO				
M-C	)1	SHEET	18	OF	28

GENERAL NOTES

- THE INSTRUCTIONS SHALL BE AVAILABLE ON THE JOB SITE PER IMC 304.1
- COORDINATION OF VARIOUS TRADES IS THAT OF THE GENERAL CONTRACTOR.
- DIMENSIONS BEFORE FABRICATION OF ANY WORK.
- D. CONTRACTOR TO PROVIDE LONG RADIUS 90DEG. ELBOWS, TURNING VANES, WYE BRANCHES, FOR DUCTWORK FITTINGS TO MINIMIZE FRICTIONAL LOSSES.
- G. PROVIDE A CHANGE OVER THERMOSTAT FOR THE THREE AIR HANDLER UNITS. PROVIDE SMOKE DETECTOR IN SUPPLY AND RETURN SIDE OF DUCTWORK. IF THERE ARE COMBUSTIBLES DETECTED BY THESE SMOKE

FIRST FLOOR-HVAC

M-01M-01 SCALE: 1/4"=1'

10**"**ø

10**"**ø

10"ø

10"ø

EF-3(1)

SA2 255 TYP OF 4

8"ø

AHU-2

( wh )

14x14

18x14

\_ FLOOR


RA1 255 TYP OF 4

HP-3

reservate de la composition della composition de

OVERHEAD

18x14

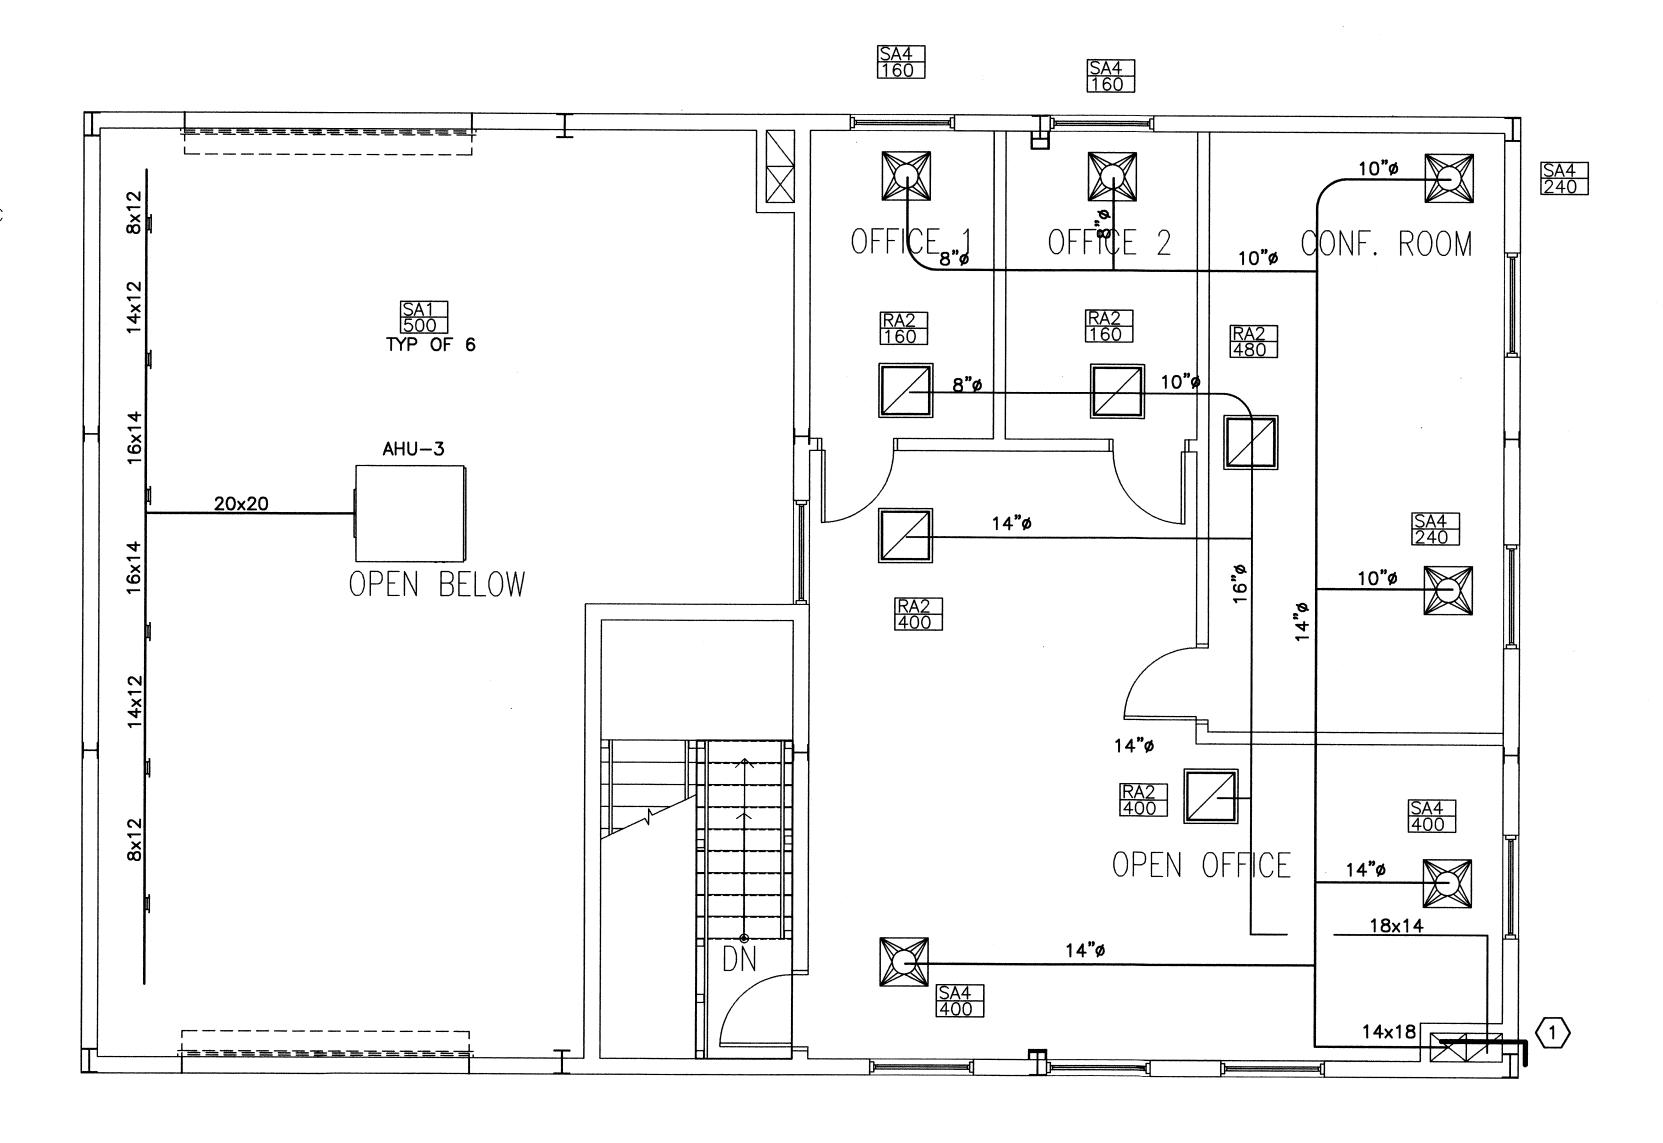



#### GENERAL NOTES

- A. ALL WORK SHALL CONFORM TO THE LATEST EDITION OF MECHANICAL, GAS, PLUMBING, AND ELECTRICAL CODES FOR THE AUTHORITIES HAVING JURISDICTION. ALL LISTED AND NON-LISTED APPLIANCES ARE TO BE INSTALLED PER IMC 304.1 AND IFGC 306.5. EVERY APPLIANCE SHALL BE LOCATED WITH RESPECT TO BUILDING CONSTRUCTION AND OTHER EQUIPMENT SO AS TO PERMIT ACCESS AND SERVICE PER IMC SECTION 303. EQUIPMENT SHALL BE INSTALLED PER MANUFACTURER'S INSTRUCTIONS. THE INSTRUCTIONS SHALL BE AVAILABLE ON THE JOB SITE PER IMC 304.1
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  ARE FOR CLEAR DIMENSIONS. APPLY A 1" EXTERNAL
  INSULATION TO ALL DUCTWORK. DUCTWORK TO BE
  GALVANIZED STEEL. FLEX DUCT CAN BE ONLY USED 6
  FEET WITHIN DIFFUSER.
- G. PROVIDE A CHANGE OVER THERMOSTAT FOR THE THREE AIR HANDLER UNITS. PROVIDE SMOKE DETECTOR IN SUPPLY AND RETURN SIDE OF DUCTWORK. IF THERE ARE COMBUSTIBLES DETECTED BY THESE SMOKE DETECTORS, THEN THE PACKAGED UNITS SHALL SHUT DOWN.

## KEYED NOTES


1 PROVIDE FIRE DAMPER FOR SUPPLY AND RETURN DUCTWORK.

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U. S. COAST GUARD CIVIL ENGINEERING UNIT CLEVELAND



USCG. CEU CLEVELAND
1240 EAST 9TH STREET
CLEVELAND, OH 44199-2060

ISSUE		
MARK	DATE	DESCRIPTION

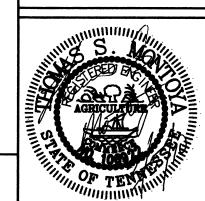CAD FILE NAME:	C7648M02
DESIGNED BY:	TSM
DRAWN BY:	TSM
DITED BY:	TSM
CHECKED BY:	JGM

SCALE: AS SHOWN PLOT SCALE: 1:1

SHEET TITLE

REPLACE PUBLIC WORKS SHOP
CG SECTOR NORTH CAROLINA
ATLANTIC BEACH NORTH CAROLINA
PUBLIC WORKS SHOP
MECHANICAL

FLOOR PLAN MECHANICAL

REVIEWED BY:	REVIEWED	7	REVIEWED BY:			
LA MERSEY	B. VRA	NKAR -	G.S. PLACZEK			
PROJECT ENG.	BRANCH	CHIEF	TECH. DIRECTOR			
7. A. Hend J. A. HE APPROVII	ALY, CA		02/01/10 DATE			
PROJECT NU	MBER	DR/	AWING NUMBER			
05-C05	5124	7648-D				
DISCIPI INF /	CUT NO					

SHEET 19 OF 28


4' 2' 0 1' 2' 4' 6' 8' 10'

SCALE: 1/4" = 1'-0"


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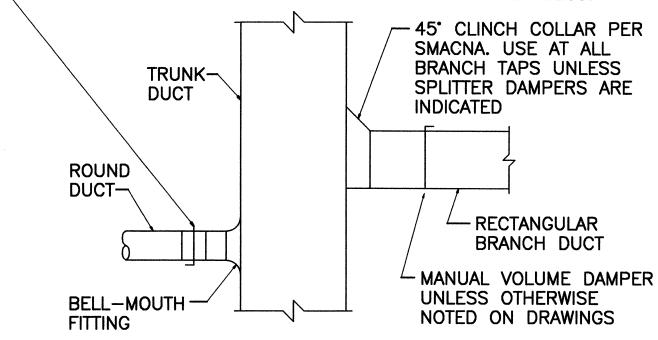



TYPICAL DIFFUSER MOUNTING

M-03M-03NOT TO SCALE

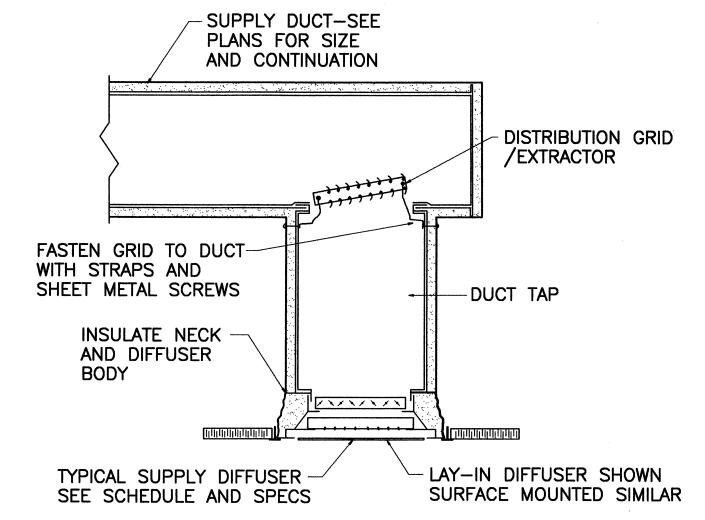NOTE:
DAMPERS SHALL BE PROVIDED IN ALL BRANCH RUN-OUTS TO DIFFUSERS, GRILLES AND REGISTERS UNLESS SPECIFICALLY NOTED OTHERWISE ON DRAWINGS. DAMPERS ABOVE INACCESSIBLE CLG. SHALL BE COORDINATED WITH ACCESS DOORS. IF DAMPERS OCCUR IN AREAS NOT ACCESSIBLE FROM ACCESS DOORS PROVIDE OPERATOR ROD AND CLG. REGULATOR WITH GASKET AND SEALED CEILING PENETRATION.

PROVIDE MANUAL OPPOSED BLADE VOLUME DAMPER IN BRANCH LINE UNLESS OTHERWISE NOTED ON DRAWINGS. DAMPERS SHALL BE INSTALLED IN ACCESSIBLE LOCATION NEAR TRUNK DUCT AND MINIMUM OF 5'-0" FROM ANY AIR INLET OR OUTLET DEVICE. COORDINATE WITH ACCESS DOORS IN NON-ACCESSIBLE CLGS.

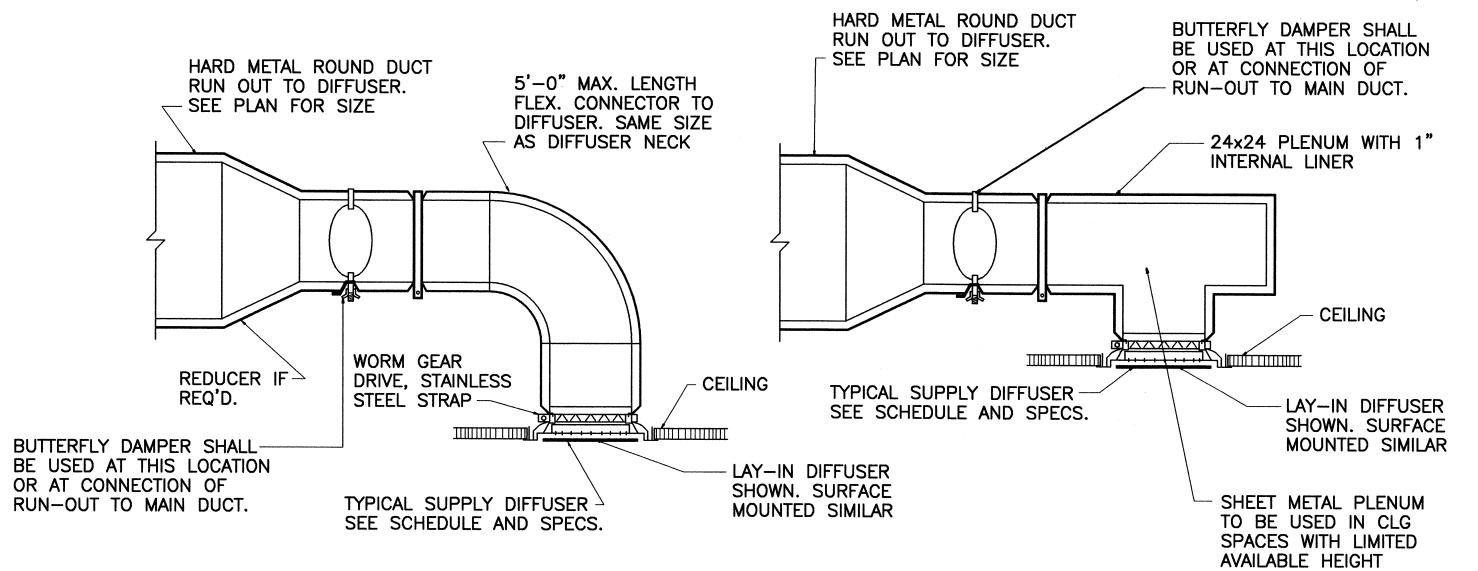

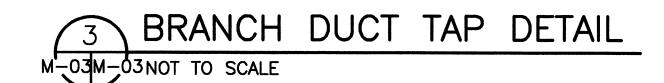

EXHAUST FAN SCHEDULE											
MARK	TYPE	CFM	ESP	HP	RPM	POWER	DRIVE	REMARKS			
EF1	CEILING, EXHAUST	150	0.125"	1/40	1050	120/1/60	DIRECT	NOTES 1,2			
EF2	CEILING, EXHAUST	75	0.125"	1/40	1050	120/1/60	DIRECT	NOTES 1,2			
EF3	CEILING, EXHAUST	150	0.125"	1/40	1050	120/1/60	DIRECT	NOTES 1,2			
NOTE 1: PROVIDE GRAVITY BACKDRAFT DAMPER. NOTE 2: PROVIDE A RAIN CAP.											

	GRILLE, REGISTER AND DIFFUSER SCHEDULE												
MARK	TYPE	-	USI R	-	MTG	PANEL SIZE	NECK SIZE		MAX FPM	MAX PD	DAMPER	FINISH	PATTERN
SA-1	GRILLE	X			DUCT	10"x8"	SEE F	PLAN	450	.07"		OFFWHITE	SEE PLAN
SA-2	GRILLE	X			DUCT	6"x6"	SEE F	PLAN	450	.07"		OFFWHITE	SEE PLAN
SA-3	PERF	X			CEILING	18"x18"	SEE F	PLAN	450	.07"		OFFWHITE	SEE PLAN
SA-4	PERF	X			CEILING	24"x24"	SEE F	PLAN	450	.07"		OFFWHITE	SEE PLAN
RA-1	GRILLE		X		DUCT	6"x6"	SEE F	PLAN	500	.07"		OFFWHITE	SEE PLAN
RA-2	PERF		X		CEILING	24"x24"	SEE F	PLAN	500	.07"		OFFWHITE	SEE PLAN
EA-1	PER. FACE			X	CEILING	12"x12"	SEE F	PLAN	500	.07"		OFFWHITE	SEE PLAN

HEAT PUMP SCHEDULE													
MARK COOLING			COOLING HEATIN					ELECTRIC	AL	: :	MIN. CIRCUIT	MAX. FUSE	DEMARKS
IVIARA	AMBIENT	MBH	EER	AMBIENT	MBH	COP	COMP. FLA	FAN FLA	VOLTS	PHASE	<b>AMPACITY</b>	SIZE	REMARKS
HP-1	95°	45.5	13.0	47 <b>°</b>	50.8	3.10	12.0	0.9	208	1	16.0	25	
HP-2	95*	34.7	13.0	47°	41.5	3.10	12.0	0.9	208	1	11	20	
HP-3	95*	71.2	13.0	47°	82.1	3.10	12.0	0.9	208	1	31.1	40	


										AIR HAN	1DL	ER	UNIT	SCHI	EDUL	E			
MARK	TYPE		FAI	N AN	D MC	OTOR			C	OOLING			AL	JX. HEATING	}	EL	ECTRICAL		DEMARKS
IAILVIVIV	111 -	CFM	O.A.	ESP	HP	V	ø	ТМВН	SMBH	EAT (DB/WB)	LAT	APD	KW	MBH	VAC	V/ø/HZ	MCA	MOCP	REMARKS
AHU-1	VERTICAL	1600	170	.70"	1/4	208	1,	45.5	37.9	82°/67°	60°	.20"	15.36	45	208	208/3/60	52	60	
AHU-2	VERTICAL	1200	140	.70"	1/4	208	1	34.7	27.0	76.5*/65*	60°	.20"	15.36	45	208	208/3/60	50	60	
AHU-3	HORIZONTAL	3000	140	.65"	1/4	208	1	71.2	62.0	79'/62'	60.	.20"	19.2	56	208	208/3/60	96.3	100	

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U. S. COAST GUARD CIVIL ENGINEERING UNIT CLEVELAND



USCG. CEU CLEVELAND 1240 EAST 9TH STREET CLEVELAND, OH 44199-2060

ISSUE			-
	***************************************		_
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			_
			-
MARK	DATE	DESCRIPTION	_

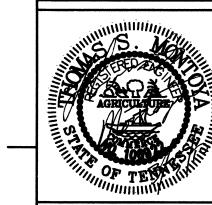DESIGNED BY: TSM
DRAWN BY: TSM
EDITED BY: TSM
CHECKED BY: JGM

SCALE: AS SHOWN PLOT SCALE: 1:1
SHEET TITLE

A/E PROJECT NO:

CAD FILE NAME: C7648M03


REPLACE PUBLIC WORKS SHOP
CG SECTOR NORTH CAROLINA
ATLANTIC BEACH NORTH CAROLINA
PUBLIC WORKS SHOP

MECHANICAL
MECHANICAL SCHEDULES

	REVIEWED BY:	REVIEWED		REVIEWED BY:
	L. L. HERSEY	B. VAX	NKAR	G.S. PLACZEK
$\mathcal{A}$	PROJECT ENG.	BRANCH	CHIEF	TECH. DIRECTOR
	9. A. Hen			
	J. A. HE	ALY, CA	PT	02/01/10
	APPROVIN	IG OFFICE	R	DATE
	PROJECT NUI	ABFR	DR	AWING NUMBER
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	05-C05	5124	7	648-D

SHEET 20 OF 28

DISCIPLINE/SHT NO M-03

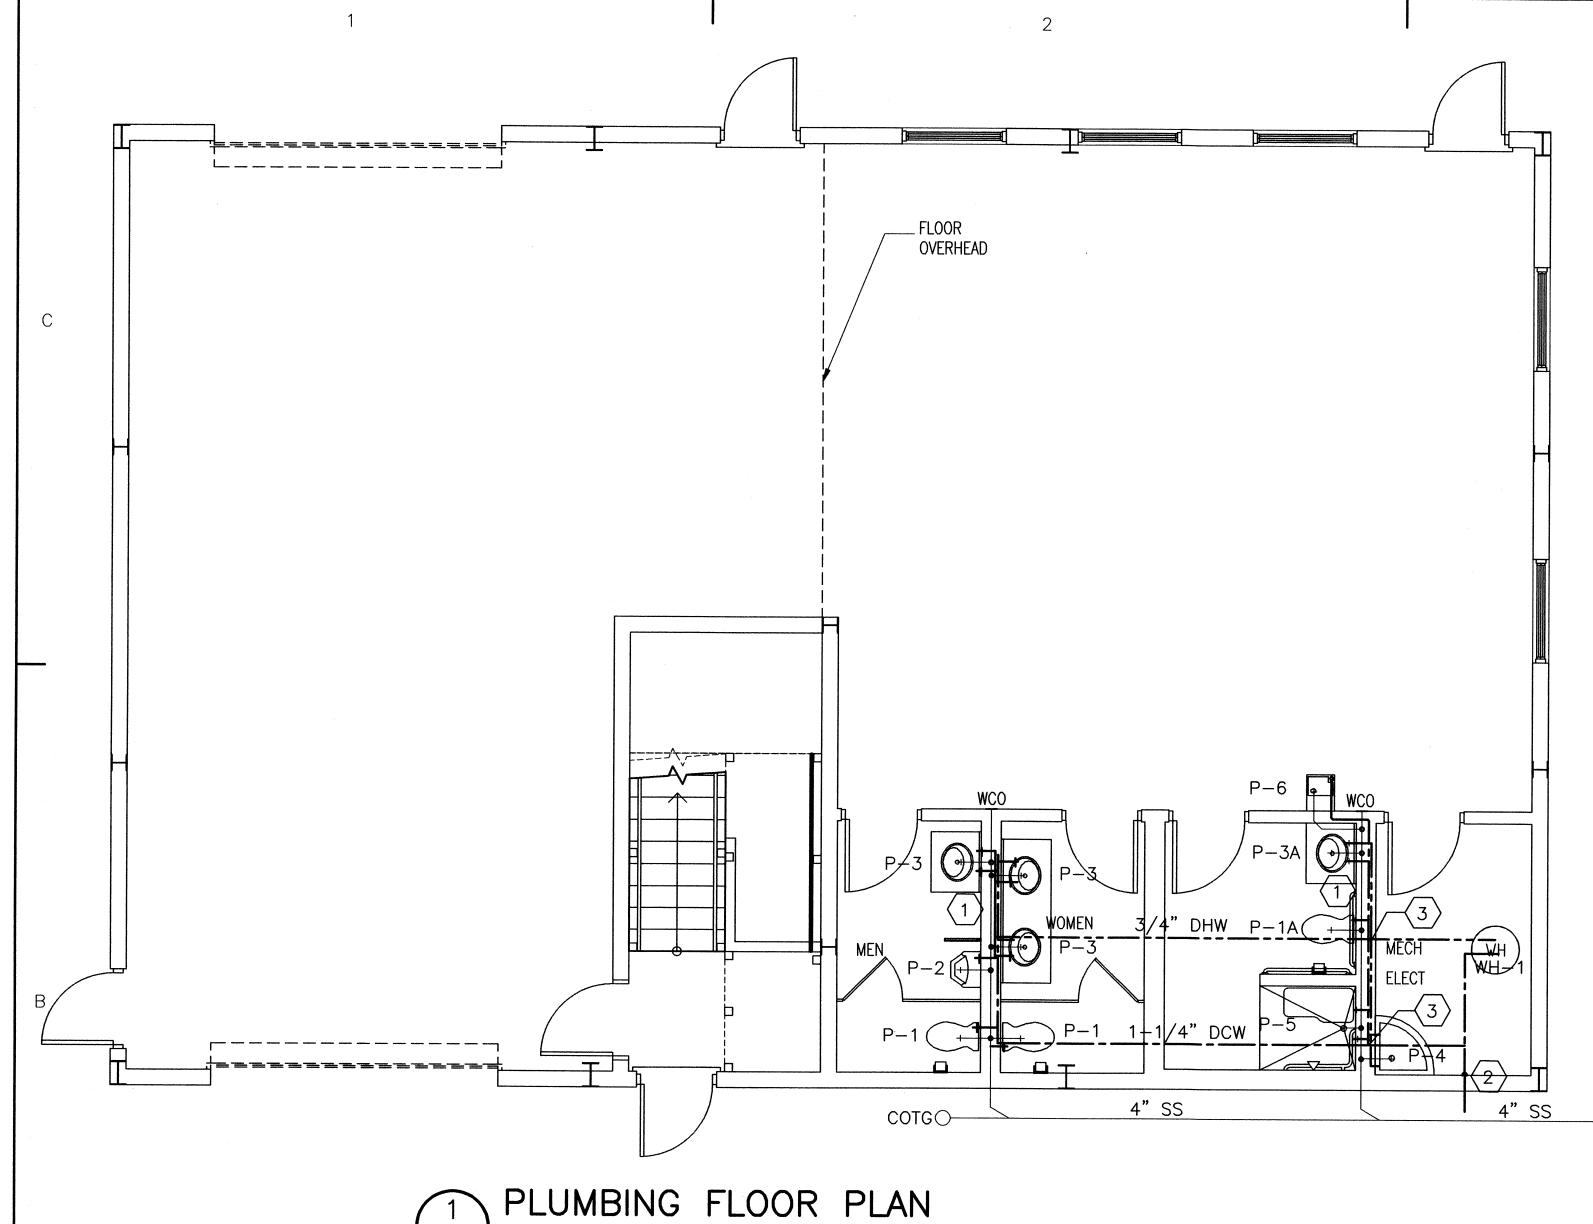

# P-01P-01 SCALE: 1/4"=1'

#### HOT WATER HEATER

	<del></del>				
MARK	TYPE	STORAGE CAPACITY	WATTAGE	POWER	REMARKS
WH-1	ELECTRIC	40 GALLONS	3 KW	208/1/60	NOTE 1,2,3,

NOTE 1. PROVIDE T&P RELIEF VALVE. ROUTE T&P DISCHARGE THROUGH EXTERIOR WALL. TURN DOWN AND TERMINATE 6" ABOVE GRADE.

NOTE 2. LEAVING WATER TEMPERATURE SHALL BE SET FOR 105 DEGREES F.

NOTE 3. TWO ELEMENTS, 3 KW PER ELEMENT.

#### PILIMBING FIXTURE SCHEDULE

MARK	DESCRIPTION	CW	HW	WASTE	INDIRECT WASTE	VENT	REMARKS
P-1	WATER CLOSET	1-1/4"		4"	-	2""	FLUSH VALVE WALL MOUNTED
P-1A	HANDICAP WATER CLOSET	1-1/4"	_	4"		2""	FLUSH VALVE WALL MOUNTED
P-2	URINAL	3/4"		2"		2""	FLUSH VALVE WALL MOUNTED
P-3	LAVATORY	1/2"	1/2"	2"	_	2""	WALL MOUNTED
P-3A	HANDICAP LAVATORY	1/2"	1/2"	2"		2""	WALL MOUNTED
P-4	MOP BASIN	3/4"	3/4"	2"	_	2"	· -
P-5	SHOWER	3/4"	3/4"	2"	-	2"	_
P-6	ELECTRIC DRINKING FOUNTAIN	3/4"	3/4"	2"	_	2"	_
COTG	CLEAN OUT THRU GRADE	-	_			·	<del>-</del>
WCO	CLEAN OUT THRU WALL	_	_				<del>-</del>

### GENERAL NOTES

- A. ALL WORK SHALL CONFORM TO THE LATEST EDITION OF MECHANICAL, GAS, PLUMBING, AND ELECTRICAL CODES FOR THE AUTHORITIES HAVING JURISDICTION.
- B. ENGINEERING DRAWINGS ARE DIAGRAMMATIC, AND WHILE THE ENGINNER HAS MADE A CONCERTED EFFORT TO ARRANGE AND LAYOUT EQUIPMENT AND PIPING IN A NON CONFLICTIVE MANNER, THE FINAL RESPONSIBILITY OF COORDINATION OF VARIOUS TRADES IS THAT OF THE CONTRACTOR.
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#### KEYED NOTES:

- PROVIDE NEW SANITARY SEWER PIPING AS INDICATED. PROVIDE NEW WASTE VENT AS INDICATED. CONNECT TO LIFT STATION.
- PROVIDE 1-1/4" DCW LINE TO BUILDING. ROUTE AS INDICATED IN BUILDING. SEE CIVIL SHEET FOR CONTINUATION
- $\overline{3}$  ROUTE  $\frac{3}{4}$ " DHW AND 1-1/4" DCW DOWN

TO LIFT

FOR

STATION; SEE CIVIL SHEET

CONTINUATION

#### PLUMBING SYMBOL LEGEND

———— DOMESTIC COLD WATER PIPING

———— DOMESTIC HOT WATER PIPING

— SANITARY DRAIN PIPING

3" VTR

---- SANITARY VENT PIPING

——— PIPING ELBOW TURNED DOWN ——— PIPING DROP DOWN

FLOOR CLEANOUT FLOOR DRAIN FD WCO WALL CLEANOUT CLEANOUT THRU GRADE


CONSULTANTS

THE JOHNSON-McADAMS FIRM GREENWOOD, MISSISSIPPI 662-455-4943

USCG CEU

CLEVELAND, OHIO

(216) 902-6200

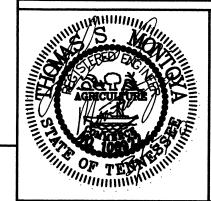

U. S. COAST GUARD CIVIL ENGINEERING UNIT **CLEVELAND** 



USCG. CEU CLEVELAND 1240 EAST 9TH STREET CLEVELAND, OH 44199-2060

MARK	DATE	DESCRIPTION

A/E PROJECT NO: CAD FILE NAME: C7648P01 DESIGNED BY: TSM DRAWN BY: TSM EDITED BY: CHECKED BY: JGM

SCALE: AS SHOWN PLOT SCALE: 1:1 SHEET TITLE

REPLACE PUBLIC WORKS SHOP CG SECTOR NORTH CAROLINA ATLANTIC BEACH NORTH CAROLINA PUBLIC WORKS SHOP **ELECTRICAL** 

FLOOR PLAN PLUMBING

REVIEWED BY:	REVIEWED	BY:	REVIEWED BY:
L. L. HERSEY	<b>B. VRA</b>	NKAR	G.S. PLACZEK
PROJECT ENG.			TECH. DIRECTOR
9. 11. Hes J. A. HE	ly		
J. A. HE	ALY, CA	PT	02/01/10
APPROVI	IG OFFICE	R	DATE
PROJECT NUI	MBER	DR	AWING NUMBER
05 005	- 4 0 4	_	0.40
05-C05	0124	/	648-D
DISCIPLINE/S	SHT NO		


SHEET 21 OF 28


WASTE/VENT RISER DIAGRAM

P-6



SCALE: 1/4" = 1'-0"

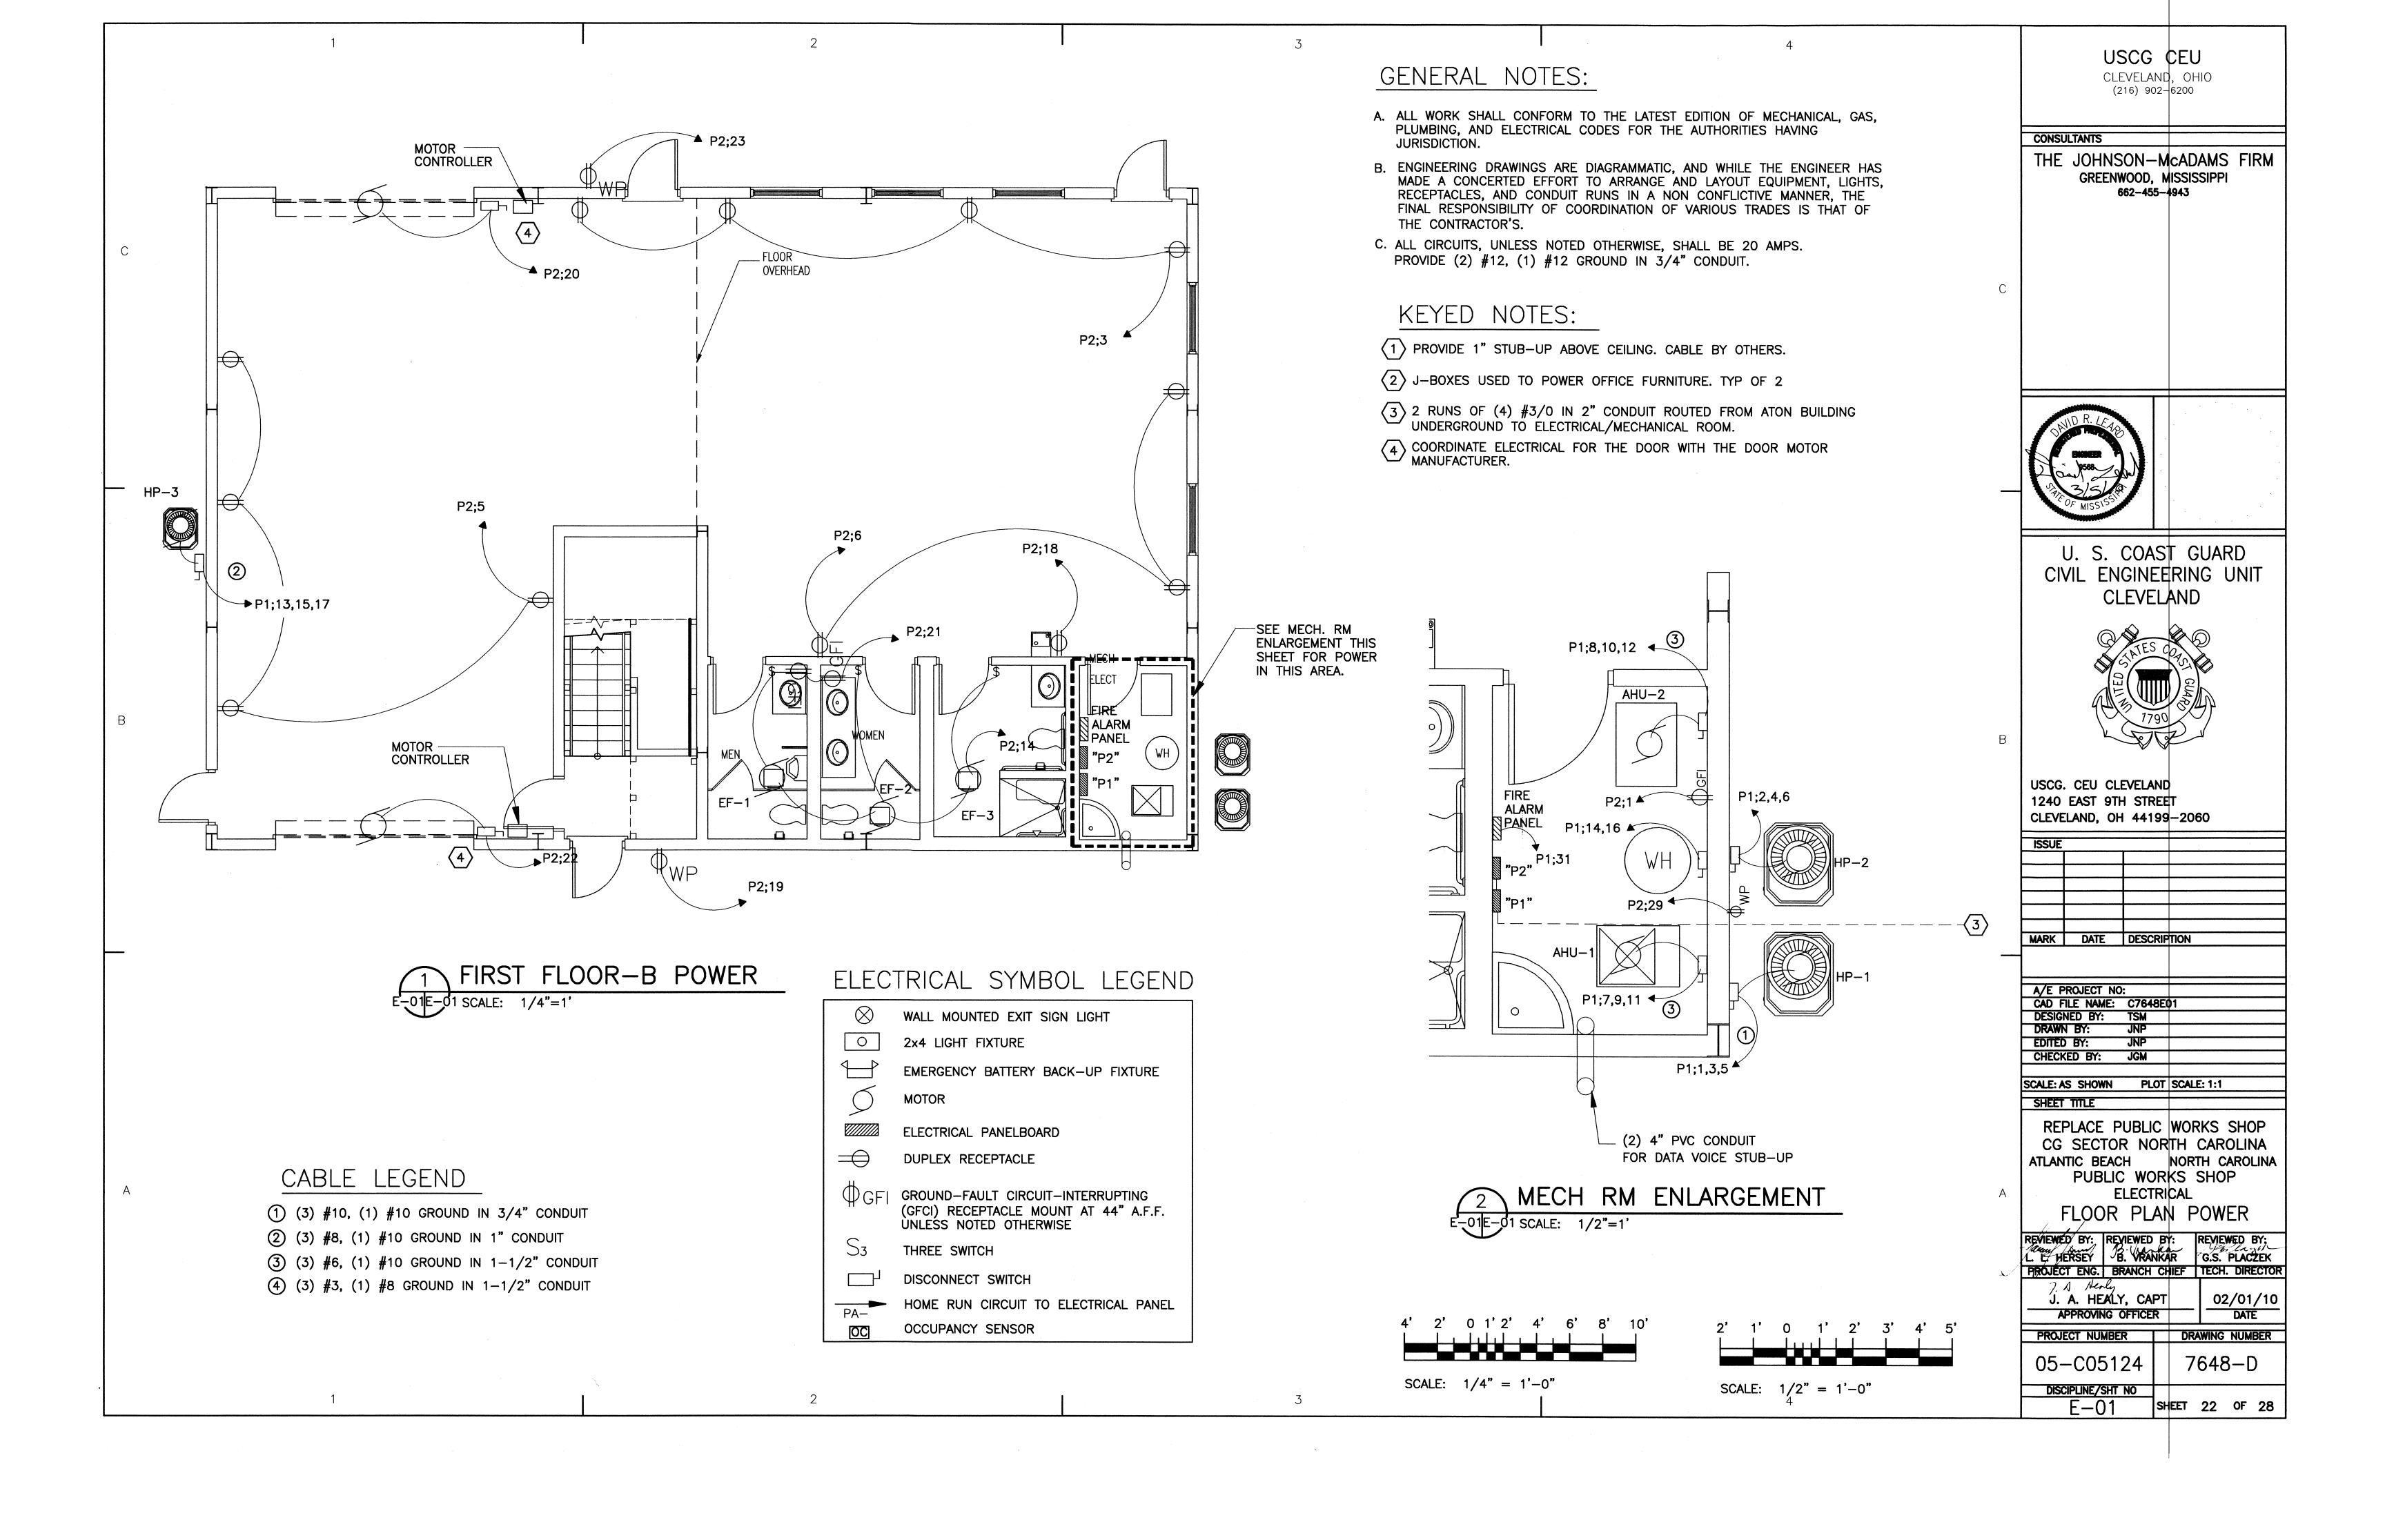

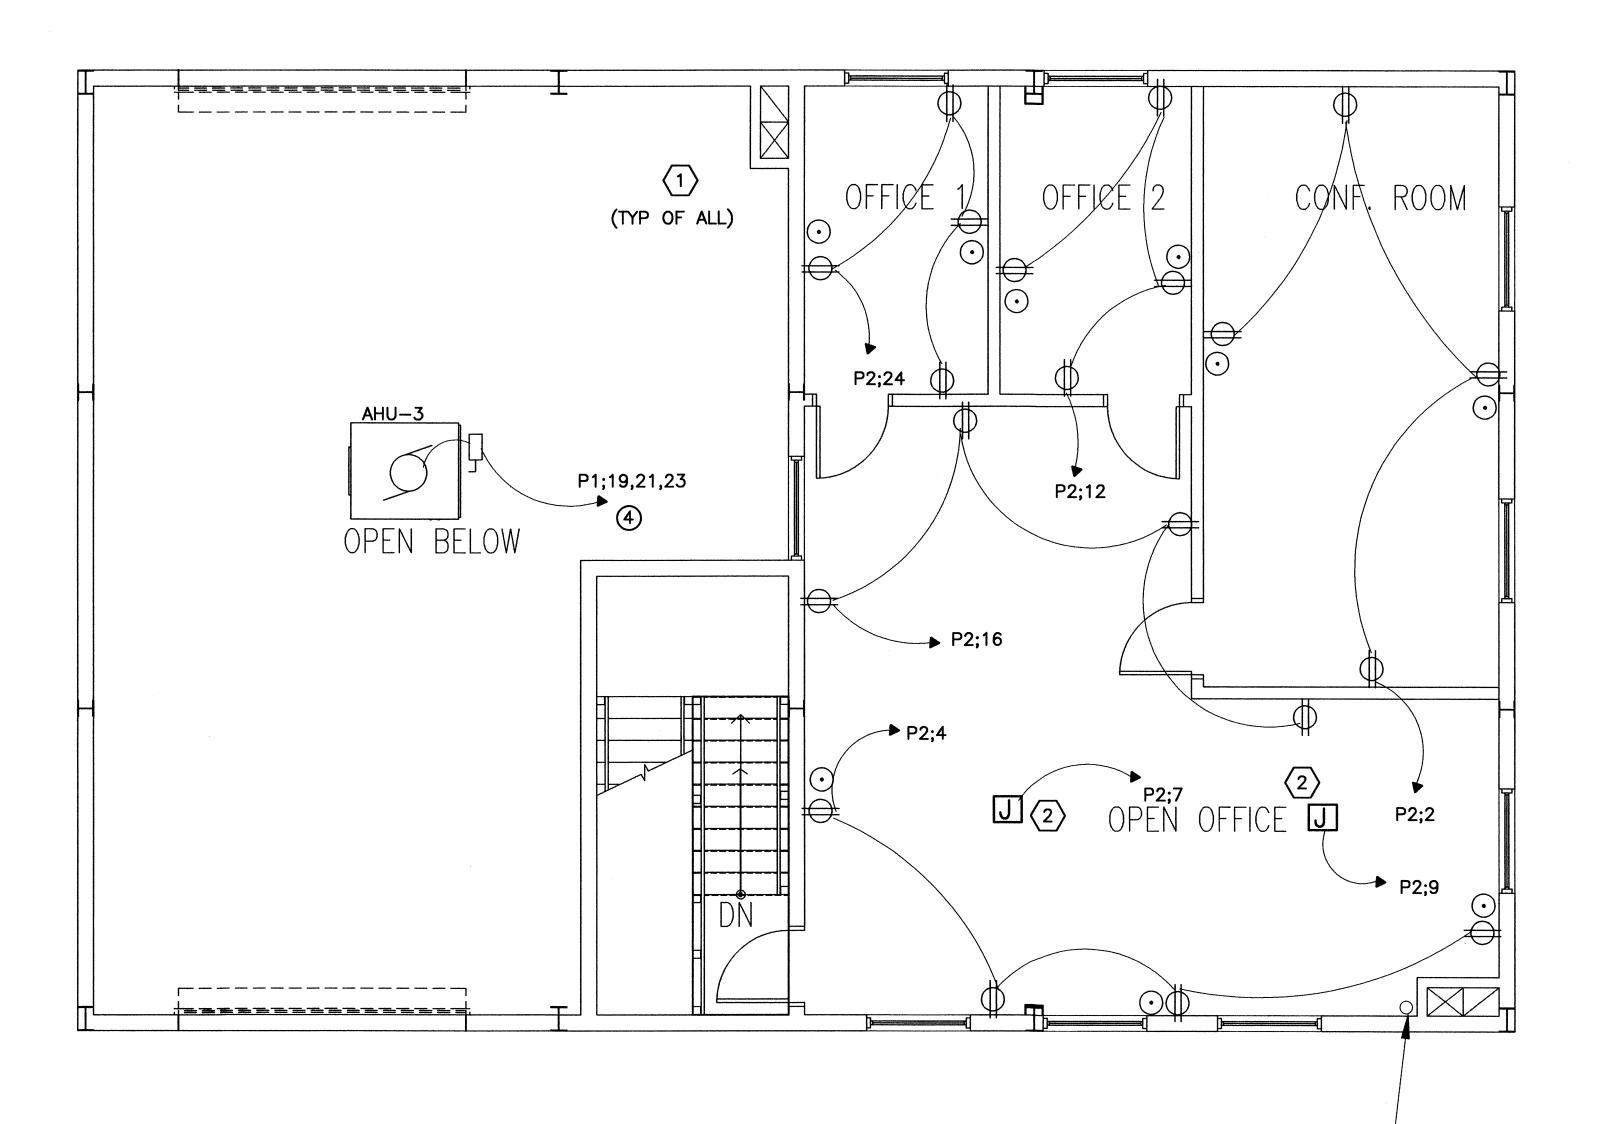

SECOND FLOOR-C POWER

GENERAL NOTES:

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- C. ALL CIRCUITS, UNLESS NOTED OTHERWISE, SHALL BE 20 AMPS. PROVIDE (2) #12, (1) #12 GROUND IN 3/4" CONDUIT.

#### KEYED NOTES:

- (1) PROVIDE 1" STUB-UP ABOVE CEILING. CABLE BY OTHERS.
- $\langle 2 \rangle$  J-BOXES USED TO POWER OFFICE FURNITURE. TYP OF 2

#### CABLE LEGEND

(1) (3) #3, (1) #8 GROUND IN 1-1/2" CONDUIT

4" PVC CONDUIT FOR DATA AND VOICE STUB-UP FROM FIRST FLOOR. SEAL FOR FIRE RATING.

4' 2' 0 1' 2' 4' 6' 8' 10'


SCALE: 1/4" = 1'-0"

USCG CEU

CLEVELAND, OHIO (216) 902-6200

CONSULTANTS

THE JOHNSON-McADAMS FIRM GREENWOOD, MISSISSIPPI 662-455-4943

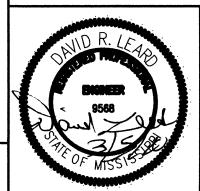

U. S. COAST GUARD CIVIL ENGINEERING UNIT CLEVELAND



USCG. CEU CLEVELAND 1240 EAST 9TH STREET CLEVELAND, OH 44199-2060

ISSUE			
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MARK	DATE	DESCRI	PTION

A/E PROJECT NO:

CAD FILE NAME: C7648ED2

DESIGNED BY: TSM

DRAWN BY: JNP

EDITED BY: JNP

CHECKED BY: JGM

SCALE: AS SHOWN PLOT SCALE: 1:1
SHEET TITLE

REPLACE PUBLIC WORKS SHOP
CG SECTOR NORTH CAROLINA
ATLANTIC BEACH NORTH CAROLINA
PUBLIC WORKS SHOP

ELECTRICAL FLOOR PLAN POWER

REVIEWED BY:

REVIEWED BY:

REVIEWED BY:

REVIEWED BY:

REVIEWED BY:

REVIEWED BY:

G.S. PLACZEK

PROJECT ENG. BRANCH CHIEF TECH. DIRECTOR

DATE


PROJECT NUMBER

DRAWING NUMBER

DISCIPLINE/SHT NO

E-02

SHEET 23 OF 28

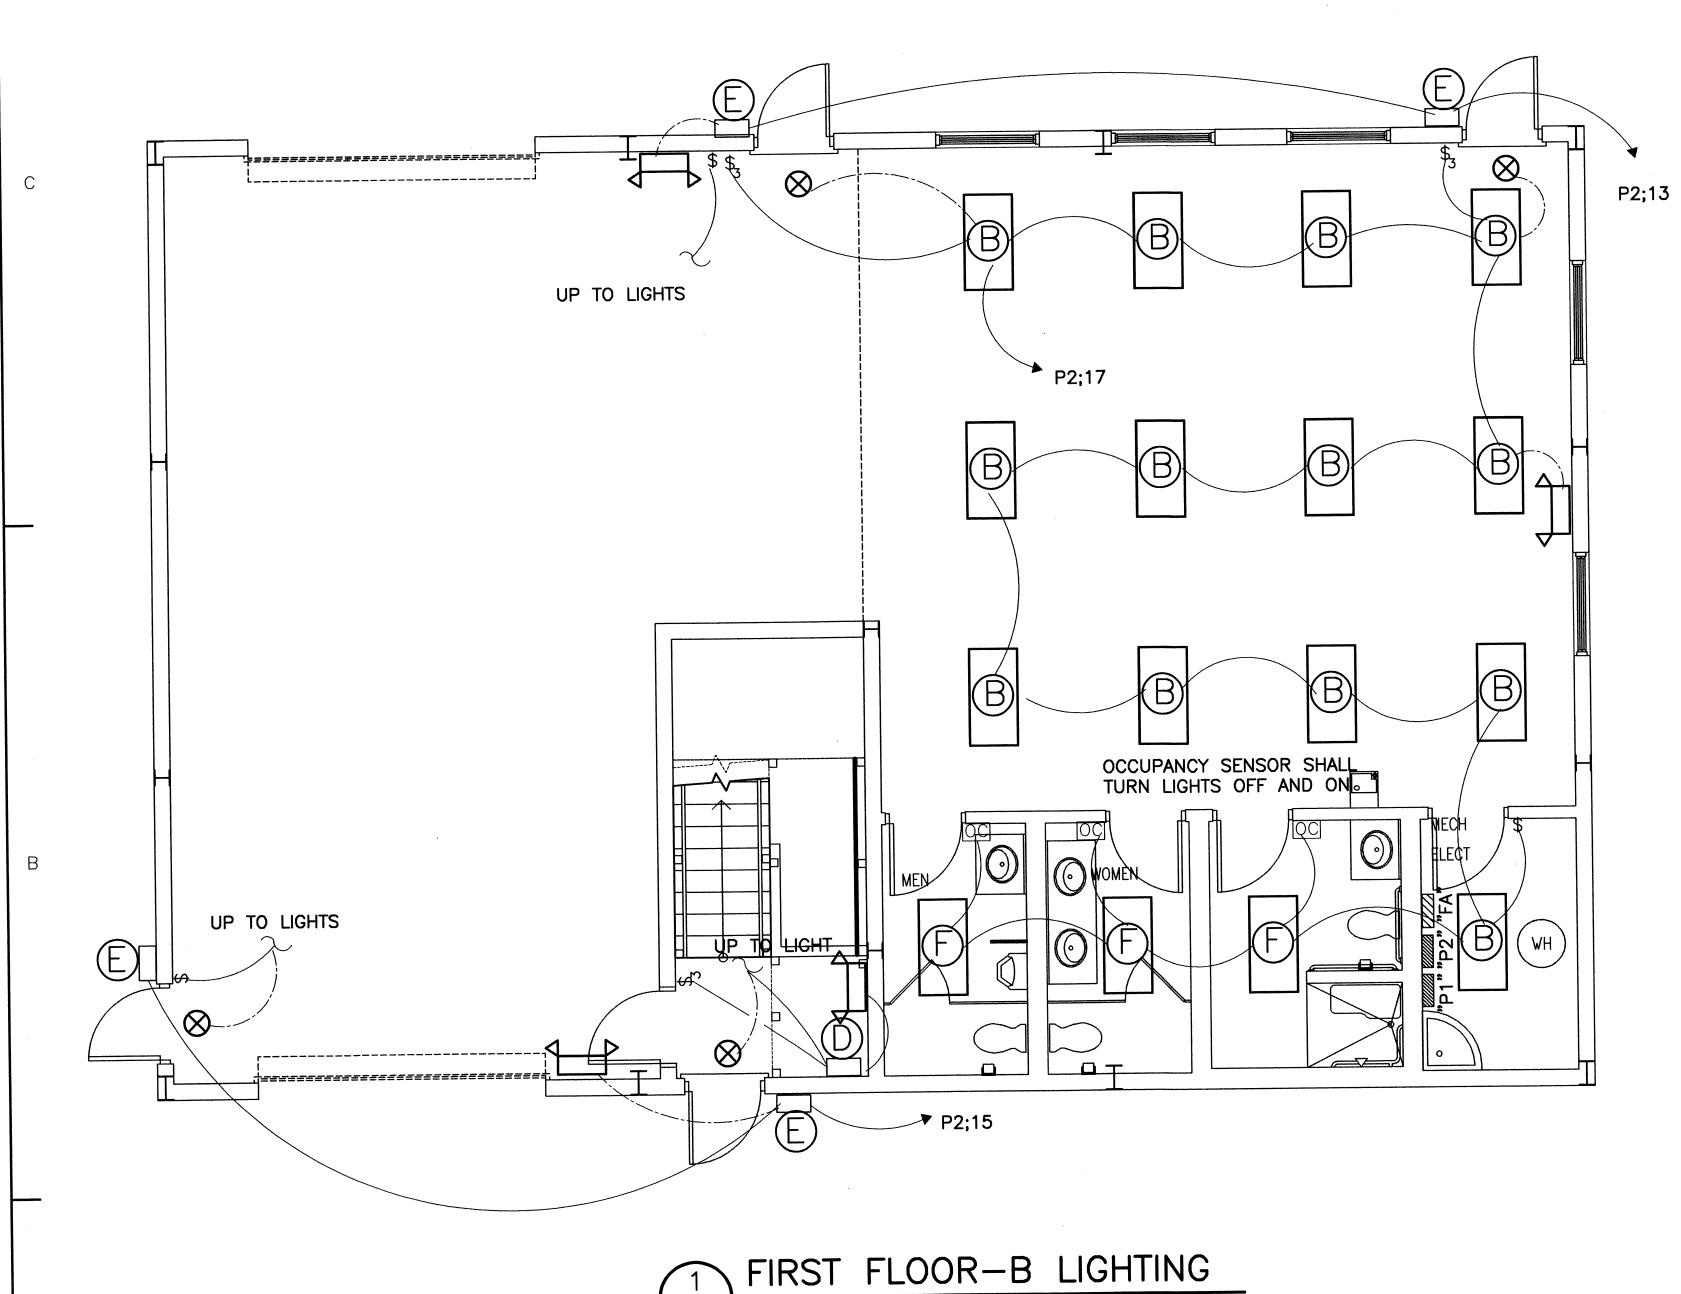

E-03E-03 SCALE: 1/4"=1'

#### GENERAL NOTES:

- A. ALL WORK SHALL CONFORM TO THE LATEST EDITION OF MECHANICAL, GAS, PLUMBING, AND ELECTRICAL CODES FOR THE AUTHORITIES HAVING
- B. ENGINEERING DRAWINGS ARE DIAGRAMMATIC, AND WHILE THE ENGINEER HAS MADE A CONCERTED EFFORT TO ARRANGE AND LAYOUT EQUIPMENT, LIGHTS, RECEPTACLES, AND CONDUIT RUNS IN A NON CONFLICTIVE MANNER, THE FINAL RESPONSIBILITY OF COORDINATION OF VARIOUS TRADES IS THAT OF THE CONTRACTOR'S.
- C. ALL CIRCUITS, UNLESS NOTED OTHERWISE, SHALL BE 20 AMPS. PROVIDE (2) #10, (1) #12 GROUND IN 3/4" CONDUIT.
- D. CONNECT ALL EMERGENCY/ BATTERY BACK-UP LIGHTS BEFORE SWITCHING.

	LIGHTING FIX	TURE SCHEDULE		
MARK	TYPE	LAMPS	VOLTAGE	NOTE(S)
Α	LAY-IN FLUORESCENT PARABOLIC, 2'x4'	2 EA. 32W T8	120 VAC	1
В	SURFACE FLUORESCENT TROFFER, 2'x4'	2 EA. 32W T8	120 VAC	1
С	HIGH BAY METAL HALIDE	250W CLEAR BT-28 MH	120 VAC	
D	WALL MOUNTED FLUORESCENT	2 EA. 25W T8	120 VAC	1
Е	WALLPACK	100W METAL HALIDE	120 VAC	2
F	LAY-IN FLUORESCENT TROFFER, 2'x4'	2 EA. 32W T8	120 VAC	1
$\otimes$	EXIT LIGHT	L.E.D.	120 VAC	3
	EMERGENCY LIGHT	6 WATT HALOGEN	120 VAC	3

NOTE 1: ELECTRONIC BALLAST.

NOTE 2: PROVIDE WITH PHOTOCELL CONTROL
NOTE 3: ALL EMERGENCY & EXIT LIGHTS TO HAVE NICKEL—CADIUM BATTERY BACK—UP.


CONSULTANTS

U. S. COAST GUARD CIVIL ENGINEERING UNIT CLEVELAND

USCG ¢EU

CLEVELAND, OHIO (216) 902–6200

THE JOHNSON-McADAMS FIRM GREENWOOD, MISSISSIPPI 662-455-4943

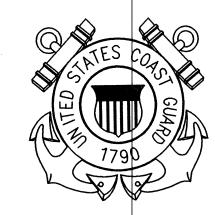

USCG. CEU CLEVELAND 1240 EAST 9TH STREET CLEVELAND, OH 44199-2060

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	MARK	DATE	DESCR	PTION	
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l		TLE NAME:		E03	
		NED BY:	TSM JNP		
		D BY:	JNP	<u> </u>	
		KED BY:	JGM		
	SCALE: /	AS SHOWN	PLO	OT SCALE: 1:1	
	SHEE	TITLE			_
	חר			WORKS SHOP	
				RTH CAROLINA	_
	ATLAN	NTIC BEA		NORTH CAROLIN	A
				RKS SHOP	
١			ELECTI		
	F	LOOR	PLA	N LIGHTING	
	<i>j</i>				

1						
ħ	REVIEWED BY:	REVIEWED	BY:	REVIEY	WED E	3 <b>Y</b> :
+	LANGE BERSEY	B. VRAN	KAR 1		PLACZ	
<i>X</i>	PROJECT ENG.	BRANCH	CHIEF	TECH.	DIRE	CTOR
	J. H. Hen J. A. HE APPROVIN			_02	/01 DATE	
F	PROJECT NU	MBER	DR	AWING	NUM	BER
	05-05		7	648	3—C	)
t	DISCIPLINE/	SHT NO				
Ī	E-C	)3	SHEET	24	OF	28

SCALE: 1/4" = 1'-0"

SECOND FLOOR—C LIGHTING

E-04E-04 SCALE: 1/4"=1"

USCG CEU


CLEVELAND, OHIO (216) 902–6200

CONSULTANTS

THE JOHNSON-McADAMS FIRM GREENWOOD, MISSISSIPPI 662-455-4943

# GENERAL NOTES:

- A. ALL WORK SHALL CONFORM TO THE LATEST EDITION OF MECHANICAL, GAS, PLUMBING, AND ELECTRICAL CODES FOR THE AUTHORITIES HAVING JURISDICTION.
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- D. CONNECT ALL EMERGENCY/ BATTERY BACK-UP LIGHTS BEFORE SWITCHING.

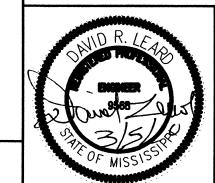

U. S. COAST GUARD CIVIL ENGINEERING UNIT CLEVELAND



USCG. CEU CLEVELAND 1240 EAST 9TH STREET CLEVELAND, OH 44199-2060

		+	
		-	
MARK	DATE	DESCRIP	TOM

CAD FILE NAME: C7648E04

DESIGNED BY: TSM

DRAWN BY: JNP

EDITED BY: JNP

CHECKED BY: JGM

SCALE: AS SHOWN PLOT SCALE: 1:1
SHEET TITLE

A/E PROJECT NO:

REPLACE PUBLIC WORKS SHOP
CG SECTOR NORTH CAROLINA
ATLANTIC BEACH NORTH CAROLINA
PUBLIC WORKS SHOP
ELECTRICAL

FLOOR PLAN LIGHTING


	REVIEWED BY:	REVIEWED	BY	,	REVIE	WED	BY:
	L/L. HERSEY	B. VRA	NKAI	<b>?</b>	G.S.	PLAC	ZEK
4	PROJECT ENG.	BRANCH	CH	EF	TECH	. DIR	<b>ECTO</b>
	9. A. HE J. A. HE			02	02/01/10		
	APPROVI			DAT	E		
	PROJECT NUI	MBER		DR	AWING	NUM	BER
	05-C05			7	648	3–[	)
	DISCIPLINE/	SHT NO					
	E-0	4	SHE	ET	25	OF	28

4' 2' 0 1' 2' 4' 6' 8' 10'

SCALE: 1/4" = 1'-0"

PANEL: <u>"P1"</u>	42 5	'208 VOLT SPACES DO AIC BR			KER	S		400A MA COPPER EQUIPME		NDING	TYPE NOOD  NEMA 1 ENCLOSURE BAR SURFACE MOUNTED
SERVICE	CKT.	CONN. LOAD	BRKR.	ļ		ASE B (		BRKR.	CONN. LOAD	CKT. NO.	SERVICE
HP-1	1 3 5	1922 1922 1922	25			-	_	20	1321 1321 1321	2 4 6	HP-2
AHU-1	7 9 11	6245 6245 6245	60			-	_	50	6005 6005 6005	8 10 12	AHU-2
HP-3	13 15 17	3735 3735 3735	40		_	-		30 2 2 20	3002 1729	14 16 18	DWH-1
AHU-3	19 21	11566 11566	100	_	_	-	_	3	901 901 901	20 22	PUMP- LIFT STATION
PANEL "P2"	23 25 27	7740 7718	125	_	_	_	_	20	901 901 901	24 26 28	PUMP- LIFT STATION
SPARE SPARE	29 31 33	7229	3 20/1 20/1		_	_		40	4804 4804 4804	30 32 34	TVSS
SPACE	35					_				36	SPACE
SPACE SPACE	37 39					_				38 40	SPACE SPACE
SPACE	41		<u> </u>		_		_	<u> </u>		42	SPACE
		TOTALS VA	ØA 48141			øB 846		øC 44628	TOTALS	5	
	-	AMPS	401.0			0.0		372.0	AMPS		

PANEL: "P2"	42 SF	208 VOLT PACES O AIC BR			KER	S		125A MA COPPER EQUIPME		NDING E	TYPE NQOD NEMA 1 ENCLOSURE BAR SURFACE MOUNTED
SERVICE	CKT. NO.	CONN. LOAD	BRKR.			ASE B C		BRKR.	CONN. LOAD	CKT. NO.	SERVICE
MECH RM RECEPTACLE	1	180	20/1		-	_	_	20/1	720	2	RECEPTACLES
RECEPTACLES	3	720	20/1		-	-	_	20/1	720	4	RECEPTACLES
RECEPTACLES	5	720	20/1	_	-			20/1	540	6	RECEPTACLES
OFFICE FURNITURE J-BOX	7	2400	20/1		<del> </del>	_	_	20/1	1500	8	LIGHTS
OFFICE FURNITURE J-BOX	9	2400	20/1	_			_	20/1	1382	10	LIGHTS
LIGHTS	11	1500	20/1	<del> </del>	-			20/1	720	12	RECEPTACLES
OUTDOOR LIGHTS	13	240	20/1		<b>-</b>	_	_	20/1	144	14	EF-1, EF-2, EF-3
OUTDOOR LIGHTS	15	240	20/1	<b>—</b>		-	_	20/1	720	16	RECEPTACLES
LIGHTS	17	1229	20/1	_	-			20/1	840	18	DRINK FOUNTAIN
OUTSIDE RECEPTACLE	19	180	20/1		<b> </b>	_	_	20/1	1176	20	DOOR MOTOR
GFI RECEPTACLES	21	360	20/1	_	_		_	20/1	1176	22	DOOR MOTOR
OUTSIDE RECEPTACLE	23	180	20/1	_	-			20/1	720	24	RECEPTACLES
FIRE ALARM PANEL ("FA")	25	1200	20/1		<b>+</b>	-	_	20/1		26	SPARE
SPARE	27		20/1					20/1		28	SPARE
OUTSIDE RECEPTACLE	29	180	20/1		-	-		20/1	600	30	REMOTE ANNUNCIATOR
SPACE	31				-	_	_			32	SPACE
SPACE	33						_			34	SPACE
SPACE	35				_	-				36	SPACE
SPACE	37		,		-	-		_		38	SPACE
SPACE	39			_		<b> </b>		-		40	SPACE
SPACE	41				-					42	SPACE
		TOTALS	ØΑ			øΒ		øС	TOTALS		
		VA	7740		77	18		7229	VA		
		AMPS	65.0		64	.0		60.0	AMPS		

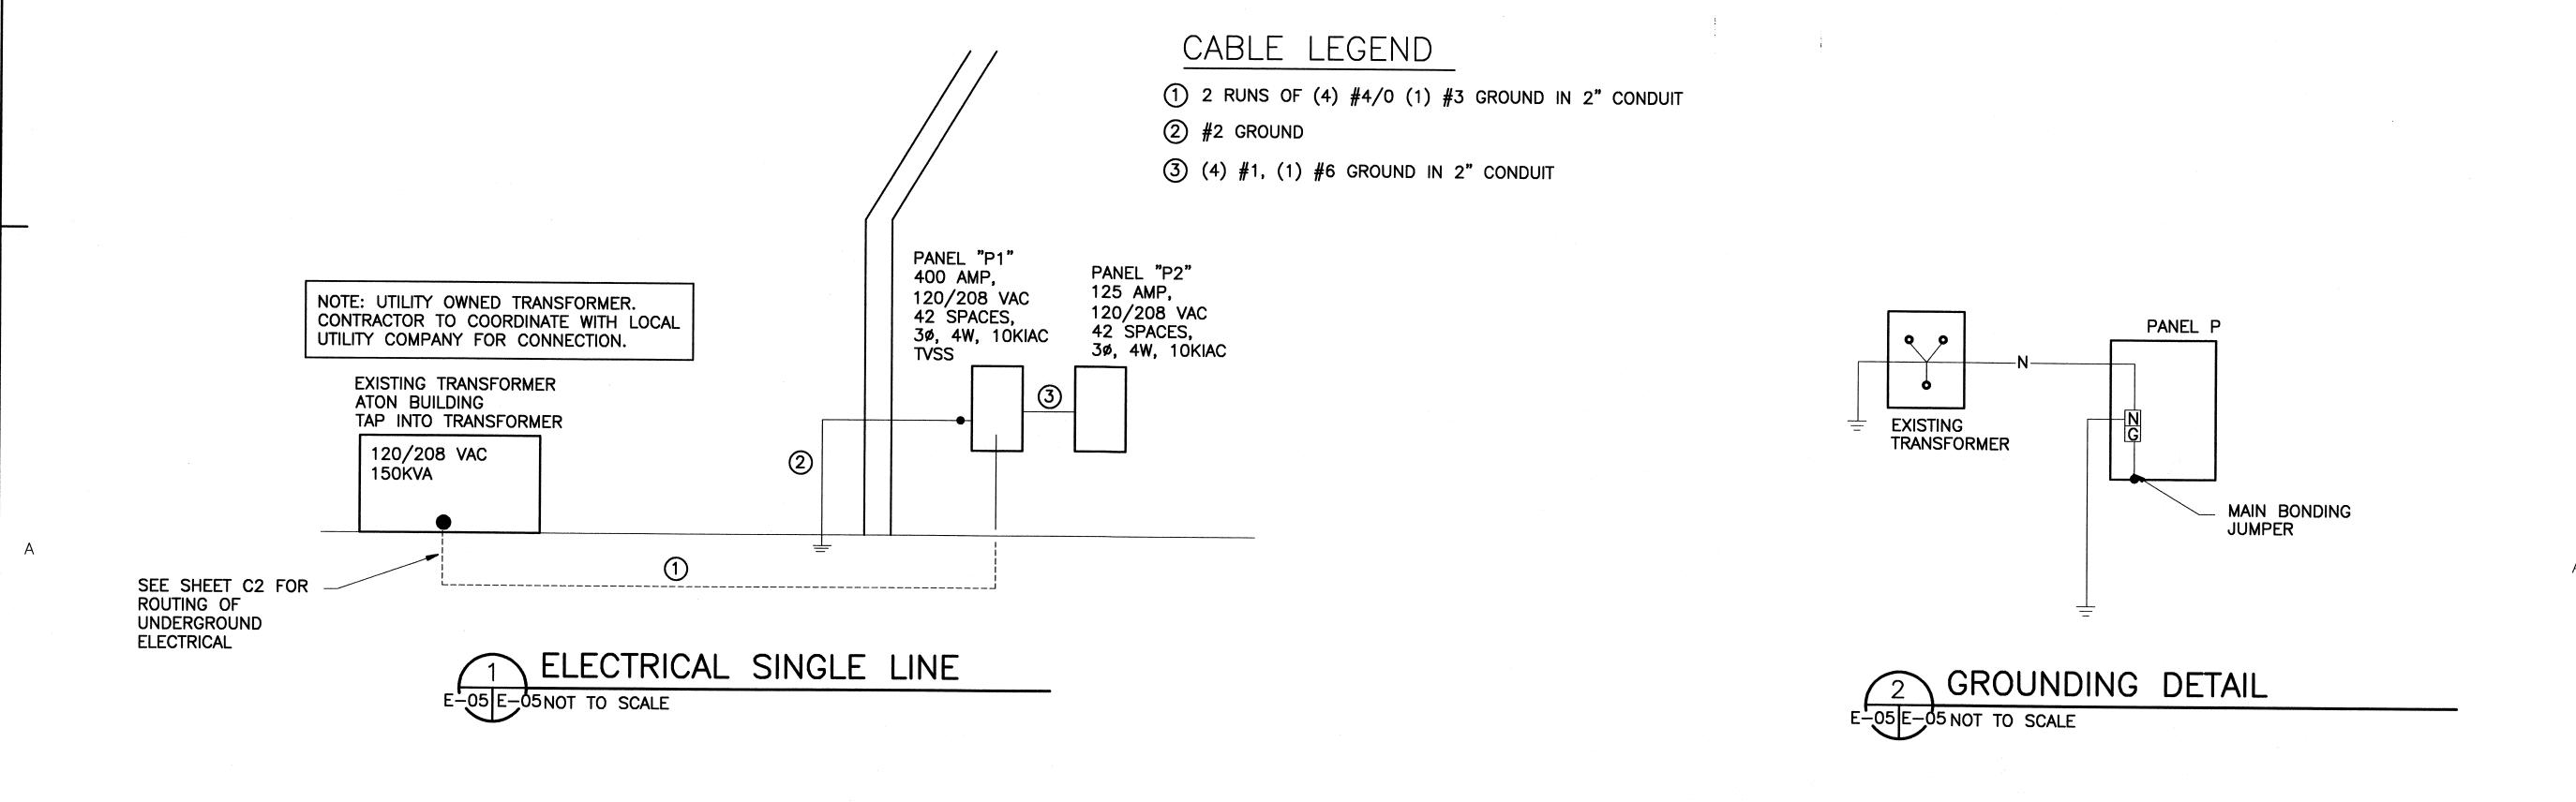


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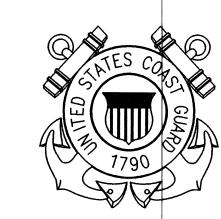
CLEVELAND, OHIO (216) 902-6200

CONSULTANTS

THE JOHNSON-MCADAMS FIRM GREENWOOD, MISSISSIPPI 662-455-4943

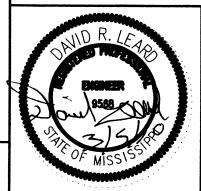

U. S. COAST GUARD CIVIL ENGINEERING UNIT CLEVELAND



USCG. CEU CLEVELAND 1240 EAST 9TH STREET CLEVELAND, OH 44199-2060

MARK	DATE	DESCRIPTI	ON
133UE			

A/E PROJECT NO:

CAD FILE NAME: C7648E05

DESIGNED BY: TSM

DRAWN BY: JNP

EDITED BY: JNP

CHECKED BY: JGM

SCALE: AS SHOWN PLOT SCALE: 1:1

SHEET TITLE

REPLACE PUBLIC WORKS SHOP
CG SECTOR NORTH CAROLINA
ATLANTIC BEACH NORTH CAROLINA
PUBLIC WORKS SHOP
ELECTRICAL

SINGLE LINE & SCHEDULES

REVIEWED BY:
HERSEY
B. VRANKAR
G.S. PLACZEK
PROJECT ENG. BRANCH CHIEF TECH. DIRECTOR
J. A. HEALY, CAPT
APPROVING OFFICER

PROJECT NUMBER

DRAWING NUMBER


05-C05124

7648-D

DISCIPLINE/SHT NO
E-05 SHEET 26 OF 28


## GENERAL NOTES:


- A. THIS DRAWING IS A SCHEMATIC REPRESENTATION OF THE REQUIRED FIRE ALARM SYSTEM. THE SCHEMATIC REPRESENTS DESIGN INTENT, NOT ACTUAL DESIGN. THE CONTRACTOR SHALL PROVIDE A COMPLETE DESIGN.
- B. THE DESIGN SHALL COMPLY TO NFPA 72, AND ALL LOCAL CODES HAVING JURISDICTION.
- C. PROVIDE DUCT SMOKE DETECTORS FOR ALL PACKAGED UNITS. PROVIDE SUPPLY AND RETURN DETECTORS. SMOKE DETECTORS SHALL BE HARD WIRED TO THE PACKAGED UNIT AND FIRE ALARM PANEL. UPON DETECTION OF COMBUSTIBLES, THE SMOKE DETECTOR SHALL SHUT DOWN THE PACKAGED UNIT AND ALARM THE FIRE ALARM.
- D. PROVIDE FIRE ALARM SYSTEM WITH BATTERY BACK UP FOR EMERGENCY POWER SOURCE.

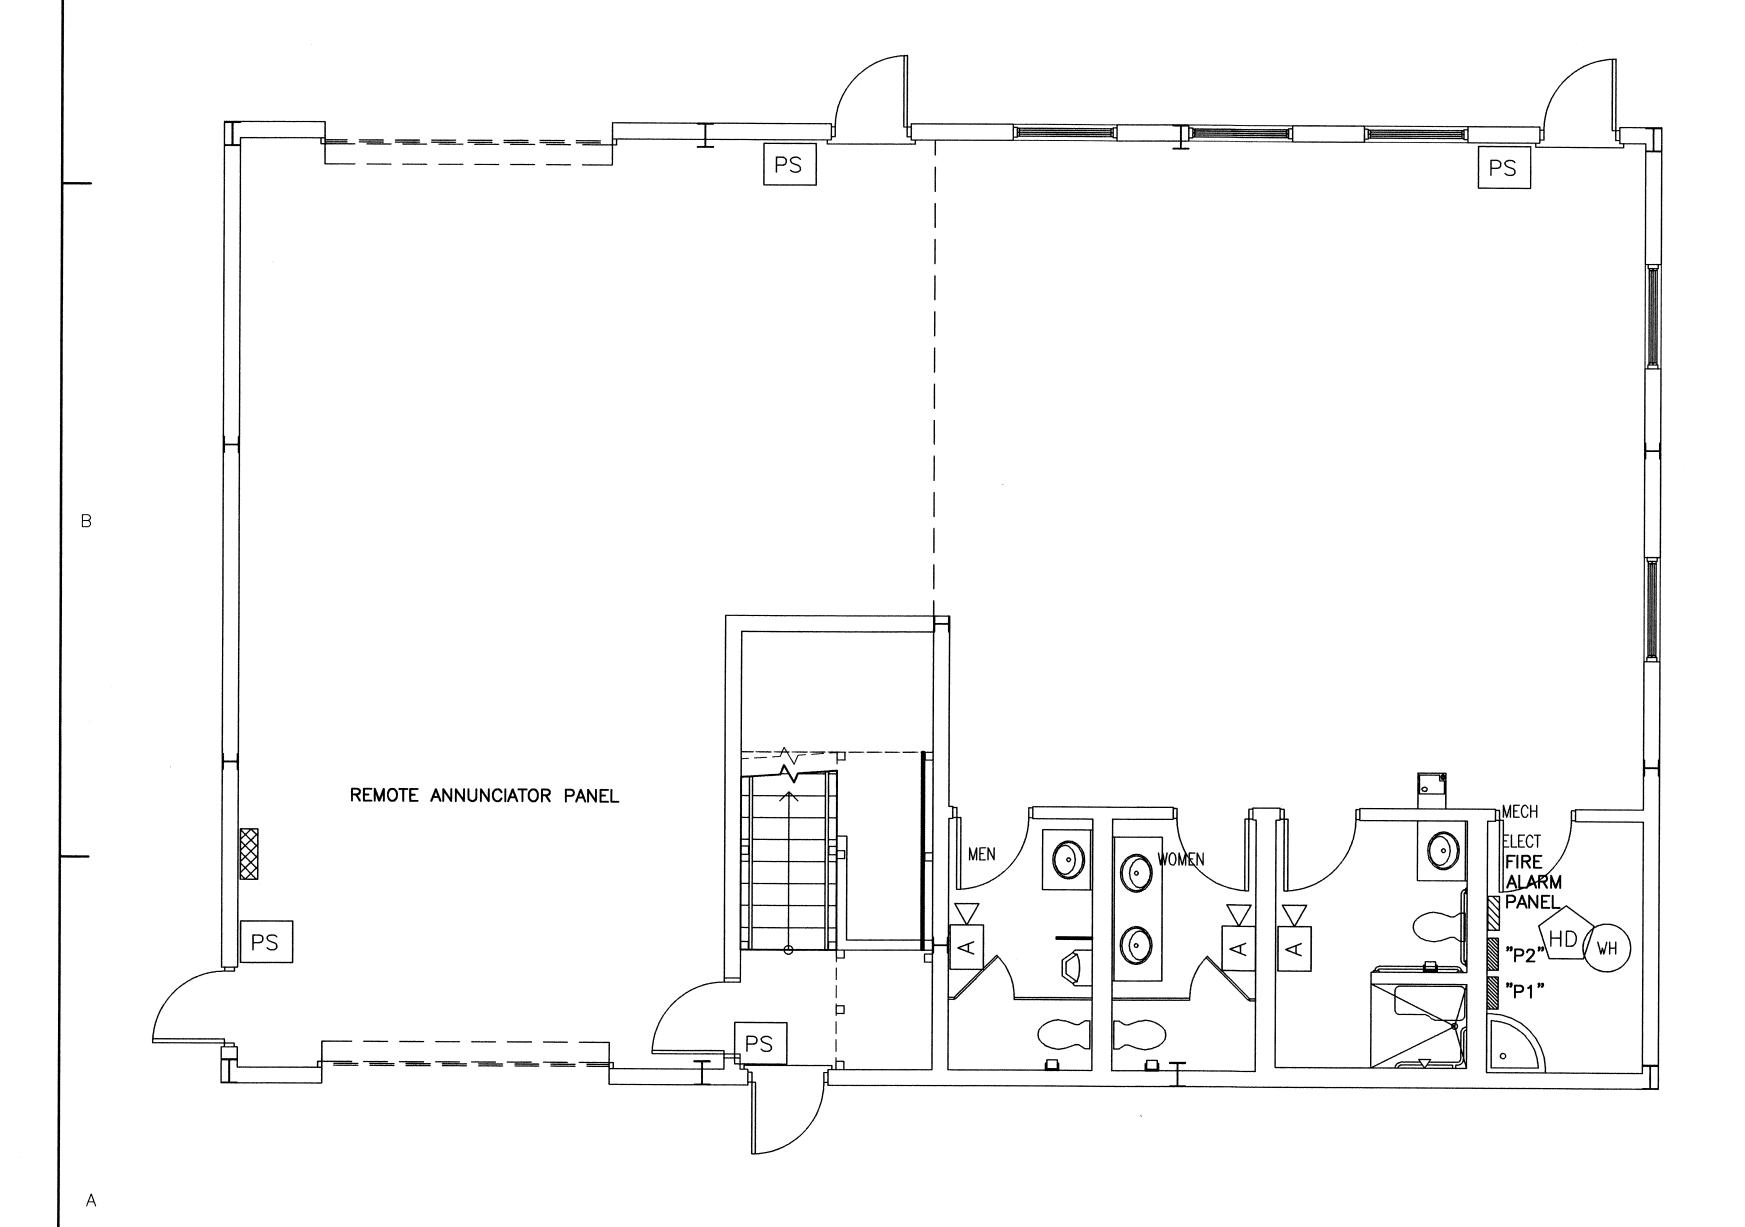

FIRST FLOOR-B FIRE ALARM

FP-01 FP-01 SCALE: 1/4"=1'

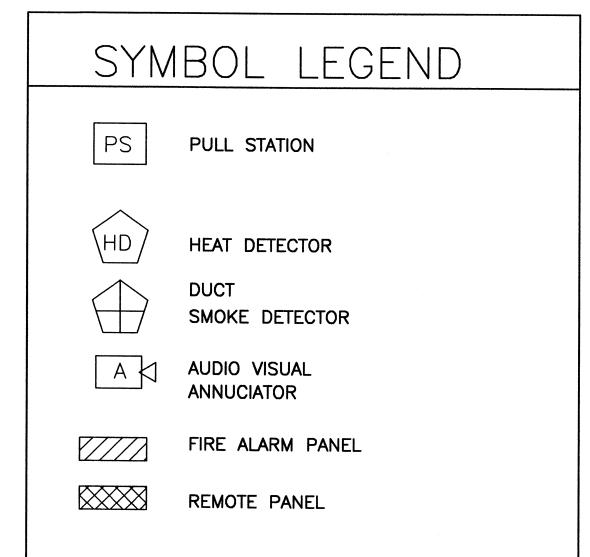

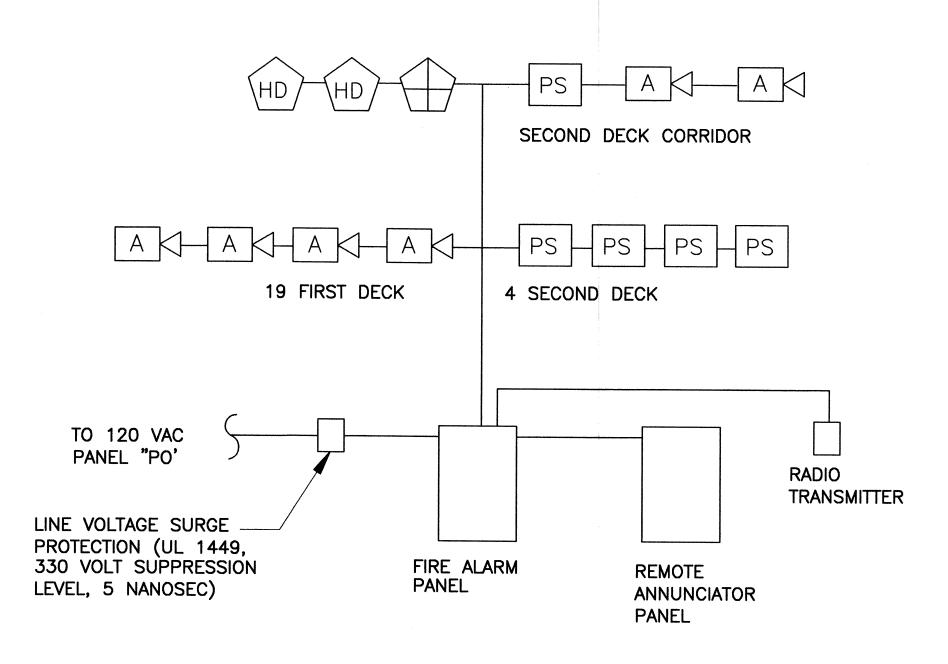





USCG CEU CLEVELAND, OHIO (216) 902-6200

CONSULTANTS

THE JOHNSON-McADAMS FIRM GREENWOOD, MISSISSIPPI 662-455-4943

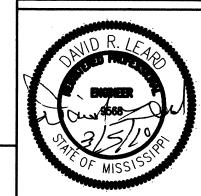

U. S. COAST GUARD CIVIL ENGINEERING UNIT CLEVELAND

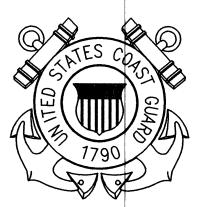

USCG. CEU CLEVELAND 1240 EAST 9TH STREET CLEVELAND, OH 44199-2060

ISSUE			
MARK	DATE	DESCRIP	TION

A/E PROJECT NO: CAD FILE NAME: C7648FP01 DESIGNED BY: TSM DRAWN BY: JNP EDITED BY: JNP CHECKED BY: JGM

SCALE: AS SHOWN PLOT SCALE: 1:1 SHEET TITLE

REPLACE PUBLIC WORKS SHOP CG SECTOR NORTH CAROLINA ATLANTIC BEACH NORTH CAROLINA PUBLIC WORKS SHOP ELECTRICAL

FLOOR PLAN FIRE ALARM

	REVIEWED BY:	REVIEWED BY		REVIEWED BY:
/	L. L. HERSEY	B. VRANKA	₹ ∤	G.S. PLACZEK
	PROJECT ENG.	BRANCH CH	EF	TECH. DIRECTO
	7. A. Hen J. A. HE		02/01/10	
	APPROVI	NG OFFICER		DATE
	PROJECT NUI	MBER	DRA	WING NUMBER

SCALE: 1/4" = 1'-0"

05-C05124 7648-D DISCIPLINE/SHT NO

FP-01 SHEET 27 OF 28

SECOND FLOOR—C FIRE ALARM


FP-02 FP-02 SCALE: 1/4"=1"

USCG CEU

CLEVELAND, OHIO (216) 902-6200

CONSULTANTS

THE JOHNSON-McADAMS FIRM GREENWOOD, MISSISSIPPI 662-455-4943

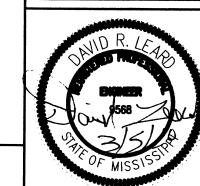

U. S. COAST GUARD CIVIL ENGINEERING UNIT CLEVELAND



USCG. CEU CLEVELAND 1240 EAST 9TH STREET CLEVELAND, OH 44199-2060

	+	

VE PROJECT NO	
CAD FILE NAME:	C7648FP02
DESIGNED BY:	TSM
DRAWN BY:	JNP
EDITED BY:	JNP
CHECKED BY:	JGM

SCALE: AS SHOWN PLOT SCALE: 1:1

SHEET TITLE

REPLACE PUBLIC WORKS SHOP
CG SECTOR NORTH CAROLINA
ATLANTIC BEACH NORTH CAROLINA
PUBLIC WORKS SHOP
ELECTRICAL

FLOOR PLAN FIRE ALARM

	REVIEWED BY:		REVIEWED BY:
	L. L. HERSEY	B. VRANKAR	G.S. PLACZEK
/	PROJECT ENG.	BRANCH CHIEF	TECH. DIRECTO
		ALY, CAPT	02/01/10
	APPROVIN	NG OFFICER	DATE

 PROJECT NUMBER
 DRAWING NUMBER

 05-C05124
 7648-D

DISCIPLINE/SHT NO SHEET 28 OF 28

**GENERAL NOTES:** 

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- D. PROVIDE FIRE ALARM SYSTEM WITH BATTERY BACK UP FOR EMERGENCY POWER SOURCE.

4' 2' 0 1'2' 4' 6' 8' 10'

SCALE: 1/4" = 1'-0"

Α